
TOWN OF TRURO, MA

COTTAGE RELOCATION AND UPGRADE 13 WALSH WAY, TRURO - MA 02655







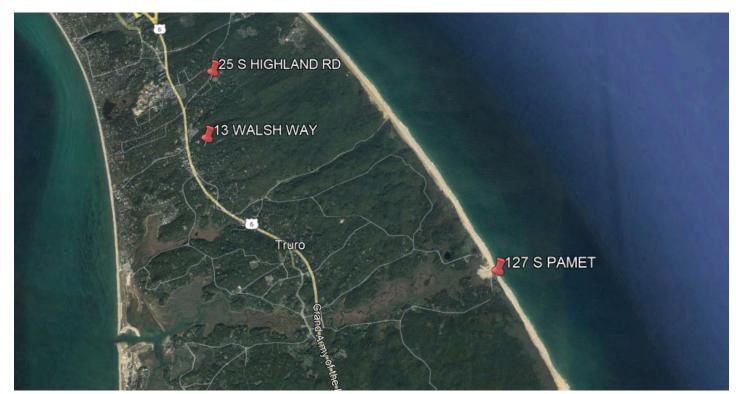



PROJECT SITE - 25 S HIGHLAND RD

G101	13 WALSH WAY - CODE SUMMARY
G102	127 S PAMET RD - CODE SUMMARY
ARCHITEC	TURAL
AD101	13 WALSH WAY - DEMOLITION FLOOR PLANS
AD102	127 S PAMET - DEMOLITION FLOOR PLANS
	TI IDAI
ARCHITEC	TURAL
A011	ABBREVIATIONS, SYMBOLS, LEGEND AND GENERAL NOTES
A101	13 WALSH WAY - OVERALL FLOOR, RCP, ROOF PLANS
A102	127 S PAMET RD - OVERALL FLOOR, RCP, ROOF PLANS
A201	13 WALSH WAY - OVERALL ELEVATIONS
A202	127 S PAMET RD - OVERALL ELEVATIONS
A231	3D VIEWS
A301	13 WALSH WAY - BUILDING, WALL AND DETAIL SECTIONS

DOOR AND FRAME TYPES

DRAWING LIST

TOWN OF TRURO - PROJECT SITES

13 WALSH WAY COTTAGE TO BE RELOCATED 127 S PAMET RD COTTAGE TO BE RELOCATED

Location Map Vicinity Map

Issue Date: 07/11/2023


Issued For: PROJECT STATUS




Weston & Sampson Engineers, Inc. 100 Foxborough Boulevard, Suite 250 Foxborough, MA 02035 978.532.1900 800.SAMF

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1	AID OCCUPITION	F	FIDE ALADA				An
A/C AC	AIR CONDITION ACOUSTICAL	FA FAAP	FIRE ALARM FIRE ALARM ANNUNCIATOR PANEL	MH MIN	MANHOLE MINIMUM	SIM	SIMILAR SANITARY NAPKIN DISPENSER
ACT	ACOUSTICAL CEILING TILE	FACP	FIRE ALARM CONTROL PANEL	MIR	MIRROR	SNV	SANITARY NAPKIN DISPENSER SANITARY NAPIKIN VENDOR
ADJ	ADJACENT	FAK	FIRST AID KIT	MISC	MISCELLANEOUS	SOLSUR	SOLID SURFACE (COUNTER)
AFF	ABOVE FINISH FLOOR	FB	FIRE BLANKET	ML	MATCH LINE	SPC	SPECIAL
alt Alum	ALTERNATE ALUMINUM	FC FD	FILE CABINET FLOOR DRAIN	MLDG MO	MOULDING MASONRY OPENING	SPEC SQ	SPECIFICATION SQUARE
	ANCHOR BOLT	FE	FIRE EXTINGUISHER	MOD	MODULAR	SR	SHEET RUBBER
ANOD	ANODIZED	FEC	FIRE EXTINGUISHER CABINET	MR	MOISTURE RESISTANT	SS	STAINLESS STEEL
	APPROXIMATE	FF	FINISH FLOOR	MRGB	MOISTURE RESISTANT GYPSUM BOARD	STD	STANDARD
ARCH ARGB	ARCHITECT ABUSE RESISTANT GYPSUM BOARD	FFE FG	FINISH FLOOR ELEVATION FIBERGLASS	MS	METAL STUD	STL	STEEL STORAGE
ASPH	ASPHALT	FIN	FINISH	MTD	MOUNTED		STRUCTURE or STRUCTURAL
AVB	AIR VAPOR BARRIER	1	FLASHING	MTL	METAL	SUSP	SUSPENDED or SUSPENSION
		FLR	FLOOR FLUORESCENT	MTP	METAL TOILET PARTITION	SV	SHEET VINYL
B BC	BASE CABINET	FND	FOUNDATION	N		SYS	SYSTEM(S)
BD	BOARD	FOC	FACE OF CONCRETE	N/A	NOT APPLICABLE	Т	
BF	BRACE FRAME	FOF	FACE OF FINISH	NAT	NATURAL	T & B	TOP AND BOTTOM
BITUM BLDG	BITUMINOUS BUILDING	FOM FOS	FACE OF MASONRY FACE OF STUD	NIC NO	NOT IN CONTRACT NUMBER	T & G TB	TONGUE AND GROOVE TRASH BARREL
BLK	BLOCK	FP	FIREPROOF(ING)	NOM	NOMINAL	TBA	TO BE ABANDONED
BLKG	BLOCKING	FR	FIRE RETARDANT	NTS	NOT TO SCALE	TBB	TILE BACKER BOARD
BM	BENCH MARK	FRP	FIBERGLASS REINFORCED WALL	NUM	NUMBER	TBD	TO BE DETERMINED
BOF	BOTTOM OF STEEL	FRTW	PANEL FIRE RETARDANT TREATED WOOD	NW	NEW	TBOC	TOP BACK OF CURB
BOS BOTT	BOTTOM OF STEEL BOTTOM	FSB	FILED SUB BID	0		TEL TEMP	TELEPHONE TEMPORARY
BPL	BEARING PLATE	FT	FEET	OA	OVERALL	THK	THICK(NESS)
BRG	BEARING	FTG	FOOTING	OC	ON CENTER	THRESH	THRESHOLD
BRK	BRICK	FUR	FURRING	OD	OUTSIDE DIAMETER	TOC	
BS BSMT	BRICK SHELF BASEMENT	G		OH OPNG	OVERHEAD DOOR OPENING	TOF TOL	TOP OF FOOTING TOP OF LANDING
BVL	BEVELED	GA	GAUGE	OPP	OPPOSITE	TOP	TOP OF LANDING TOP OF PLATE
- -	- 	GALV	GALVANIZED	OPPHAN	OPPOSITE HAND	TOS	TOP OF STEEL
С		GB	GRAB BAR	D	ODIENTED OTDAND DOADS	TOW	TOP OF WALL
CAB	CABINET	GC GDRL	GENERAL CONTRACTOR GUARD RAIL	OSB OTS	ORIENTED STRAND BOARD OPEN TO STRUCTURE	TP	TRANSLUCENT PANEL
CB CDM	CEMENT BOARD / CATCH BASIN CAVITY DRAINAGE MATERIAL	GL	GLASS	OW	OPERABLE WALL	TR TS	TREAD TUBULAR STEEL
CDIVI CF	CUBIC FEET	GLAZ	GLAZED BLOCK	OZ	OUNCE	TTD	TOILET TISSUE DISPENSER
CH	CEILING HEIGHT	GLB	GLASS BLOCK			— TW	TO WEATHER
CIP	CAST IN PLACE	GN	GOOSENECK	P PART	PARTICLE BOARD	TYP	TYPICAL
CJ Cl	CONTROL JOINT	GRT GWB	GROUT GYPSUM WALL BOARD	BD	I AITHULL DUARD		
CL CL	CENTER LINE / COLUMN LINE CLOSET / CHAIN LINK			PAV	PAVING	UC	UNDERCUT
CLG	CEILING	Н		PCP	PRECAST CONCRETE PLANK	UG	UNDERGROUND
CLOS	CLOSET	НВ	HOSE BIB	PERIM PL	PERIMETER PROPERTY LINE / PLATE	UND	UNDERSIDE (OF DECK)
CLR	CLEAR	HC	HANDICAP HEAVY DUTY	PL	PLASTIC LAMINATE	UNFIN	UNFINISHED
CMU	CONCRETE MASONRY UNIT	HD HDWR	HEAVY DUTY HARDWARE	PLAS	PLASTIC	UNO	UNLESS NOTED OTHERWISE
CNTR CO	COUNTER CASED OPENING	HM	HOLLOW METAL	PLY	PLYWOOD	UV	UNIT VENTILATOR
COL	COLUMN	HOR	HORIZONTAL	PMJF	PRE-MOLDED JOINT FILLER	V	
COMP	COMPOSITION	HP	HIGH POINT	PNT PR	PAINT PAIR	VB	VINYL BASE / VAPOR BARRIER
CONC	CONCRETE	HT HTR	HEIGHT HEATER		PREFINISHED	VCT	VINYL COMPOSITION TILE
CONST	CONSTRUCTION CONTINUOUS	HVAC	HEATING, VENTILATING, & AIR	PRFB	POURED RESIN FLOOR BASE	VERT VEST	VERTICAL VESTIBULE
CONTC	CONTRACTOR		CONDITIONING	PSF	POUNDS PER SQUARE FOOT	VEST	VERIFY IN FIELD
CONV	CONVECTOR	HW	HOT WATER	PSI	POUNDS PER SQUARE INCH	VPD	VENEER PLASTER BASE
COORD	COORDINATE	1		PT PTD	PRESSURE TREATED PAPER TOWEL DISPENSER	VS	VENT STACK
CORR	CORRIDOR	ID	INSIDE DIAMETER	PTN	PARTITION	VT	VINYL TRANSITION STRIP
CPET CPT	COMMON PATH OF EGRESS TRAVEL CARPET	IN	INCH	PVC	POLYVINYL CHLORIDE	VTS VWB	VINYL TRANSITION STRIP VINYL WALL BASE
CT	CERAMIC TILE	INCL	INCLUDED	PVMT	PAVEMENT	VWC	VINYL WALL COVERING
CTR	CENTER	INFO INSUL	INFORMATION INSULATION	Q			
CW	COLD WATER	INT	INTERIOR	QT	QUARRY TILE	W	MAGUED
CWT	CERAMIC WALL TILE CUBIC YARD	INV	INVERT			W/	WASHER WITH
<i>.</i> 1	CODIC TAND	IRGWB	IMPACT-RESISTANT GWB	R		₩/O	WITHOUT
D				R	RISER	WB	WOOD BASE
D	DRYER	J	JANITOR	R&D R&R	REMOVE & DISPOSE REMOVE AND REPLACE	WC	WALL CABINET
	DEMOUNTABLE PARTITION	JAN JST	JOIST	R&S	REMOVE AND SALVAGE	WDC	WOOD
DBL DEMO	DOUBLE DEMOLITION	JT	JOINT	RAD	RADIUS	WDC	WATERPROOFING, DAMPPROOFING, & CAULKING CONTRACTOR
DEIVIO	DRINKING FOUNTAIN			RCP	REFLECTED CEILING PLAN	WF	WIRE FABRIC
DH	DOUBLE HUNG	KD	KNUUK DUWN	RD REF	ROOF DRAIN REFRIGERATOR	WG	WIRE GLASS
DI	DRAIN INLET	KD KIP	KNOCK-DOWN 1,000 LBS		REFURBISH	WH	WALL HUNG
DIA DIAG	DIAMETER DIAGONAL	KO	KNOCKOUT	REINF	REINFORCEMENT	WIN WP	WINDOW WATER PROTECTION
DIAG DIM	DIMENSION	KPLT	KICKPLATE		RELOCATED	WP'G	WATER PROTECTION WATERPROOF(ING)
DIST	DISTANCE			REM	REMOTE	WR	WATER RESISTANT
DL	DRAIN LEADER	L	LENGTH	REQ'D	REQUIRED RESILIENT	WS	WATER STOP
DN	DOWN	L LAM	LAMINATE	REV	REVISION	WT	WEIGHT
DR DS	DOOR DOWNSPOUT	LAV	LAVATORY	RFG	ROOFING		
DS DTL	DETAIL	LBL	LABEL	RFI	RIGID FOAM INSULATION		
DW	DISHWASHER	LC	LEAD COATED CORRER	RFS	RESINOUS FLOOR SYSTEM	WWF	WELDED WIRE FABRIC
DWG	DRAWING	LCC LGMF	LEAD COATED COPPER LIGHT-GAUGE METAL FRAMING	RH RL	RIGHT HAND ROOF LADDER		
		LIN	LINOLEUM	RM	RUBBER MAT		
E EA	EACH	LLH	LONG LEG HORIZONTAL	RM	ROOM		
EF	EACH FACE	LLV	LONG LEG VERTICAL	RO	ROUGH OPENING		
EIFS	EXTERIOR INSULATED FINISH	LP LSC	LOW POINT LIFE SAFETY CODE	RT RTU	RUBBER TILE ROOF TOP UNIT		
EJ	SYSTEM EXPANSION JOINT	LT	LIGHT	RUB	RUBBER		
EL EL	ELEVATION						
ELEC	ELECTRIC	M	METER	S	OFALANT	_	
ELEV	ELEVATOR	MANUE	METER MANUEACTURER	S S.L.	SEALANT STRUCTURAL LINE	_	
EMER	EMERGENCY ENCLOSUBE	MANUF MAS	MANUFACTURER MASONRY	S.L. SACI	STRUCTURAL LINE SPRAY-APPLIED CELLULOSE		
ENCL EOC	ENCLOSURE EDGE OF CONCRETE	MAT	MATERIAL	JAOI	INSULATION		
EOC EP	ELECTRICAL PANEL		MAXIMUM	SACP	SECURITY ALARM CONTROL PANEL		
EQ	EQUAL EQUAL	MB	MOSITURE BARRIER	SAFI	SPRAY-APPLIED FOAM INSULATION		
EQUIP	EQUIPMENT	MBL	MARBLE		SCHEDULE SHOWER CURTAIN BOD		
ER	EXISTING TO REMAIN	MBM	METAL BUILDING MANUFACTURER	SCR SCW	SHOWER CURTAIN ROD SOLID CORE WOOD		
ES	EXPOSED STRUCTURE	MBR	MEMBER MEDICINE CARINET	SD	SOAP DISPENSER		
EW	EACH WAY	MC MDF	MEDICINE CABINET MEDIUM DENSITY FIBERBOARD	SECT	SECTION		
EXH EXIST	EXHAUST EXISTING	MDO	MEDIUM DENSITY OVERLAY	SF	SQUARE FEET		
and I	LAIGHNO		MECHANICAL MECHANICAL	SH	SINGLE HUNG		
EXP	EXPANSION	MECH	MEGIANICAL	SHR	SHOWER		



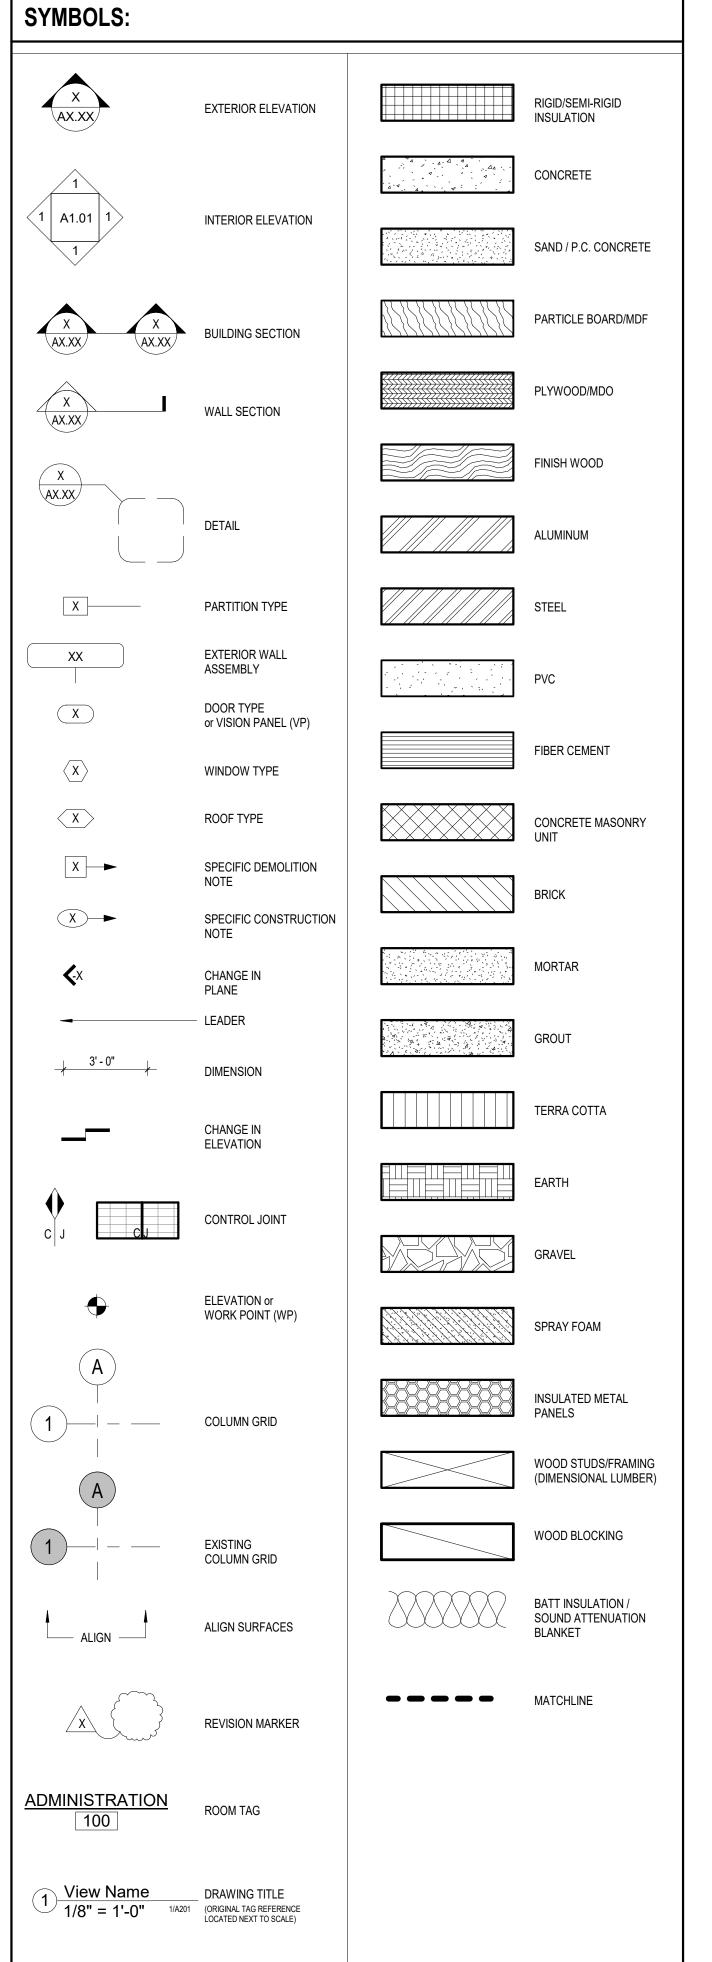

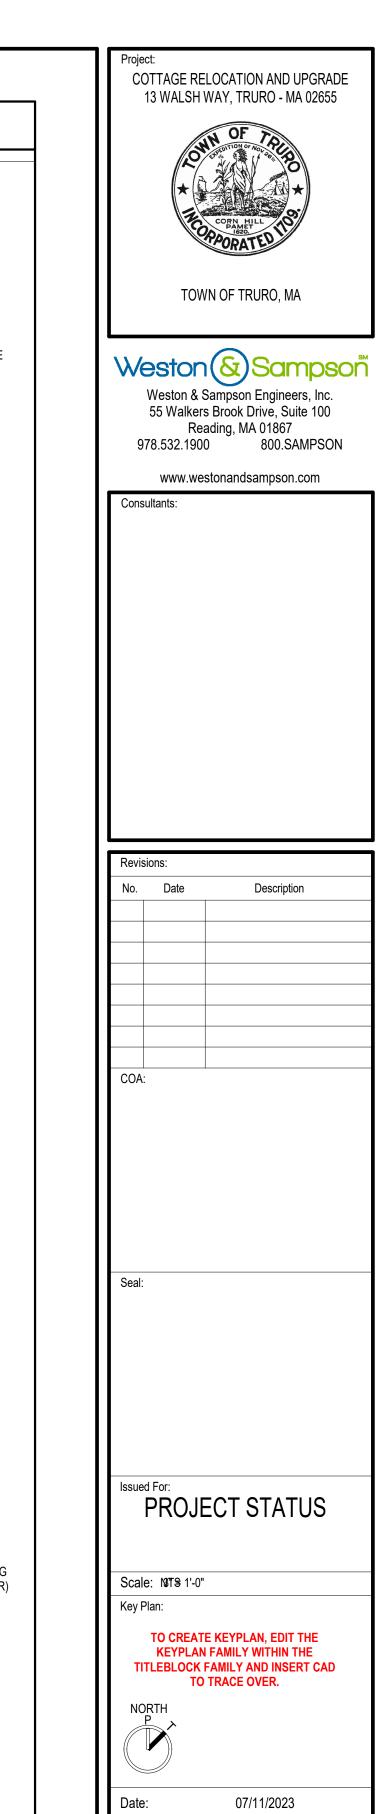Date: 07/11/2023

Drawn By: FS

Reviewed By: MP

Approved By: JRC

W&S Project No.: ENG00-00000

W&S File No.: XXX

Drawing Title:

ABBREVIATIONS, SYMBOLS, LEGEND AND GENERAL NOTES

Sheet Number:

A011





1 FIRST FLOOR DEMOLITION PLAN 1/4" = 1'-0" 1/ A201

SPECIFIC DEMOLITION NOTES:


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- REMOVE AND DISPOSE OF BRICK VENEER AND INSULATION
- REMOVE AND DISPOSE OF TRANSLUCENT PANELS
- REMOVE AND DISPOSE OF WINDOW AND FRAME
- REMOVE AND DISPOSE OF DOOR AND FRAME
- REMOVE AND DISPOSE OF METAL WALL PANEL ASSEMBLY
- REMOVE AND DISPOSE OF CMU BLOCK
- REMOVE AND DISPOSE OF INTERIOR PARTITIONS

GENERAL NOTES:

DEMOLISH ALL:

- MECHANICAL EQUIPMENT
- ELECTRICAL FIXTURES, CONDUITS, WIRING, ETC...
- PLUMBING FIXTURES, PANELS, PIPING, ETC... FIRE SUPRESSION SYSTEMS, PIPING, CONTROLS, ETC...
- EXTERIOR ELECTRICAL EQUIPMENT INCLUDING TRANSFORMERS, PANELS, CONDUITS,
- WIRING, LIGHTING, ETC ...
- EXTERIOR DRAINAGE STRUCTURES, ETC.... CUT & CAP ALL UTILITIES

PLAN LEGEND:

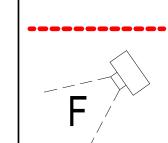

APPROXIMATE OUTLINE OF STRUCTRE / BUILDING TO BE DEMOLISHED - CONTRACTOR TO V.I.F. EXACT DIMENSIONS IN FIELD

> APPROXIMATE LOCATION AND EXTENTS OF PHOTOGRAPH

GENERAL DEMOLITION NOTES:

- CONTRACTOR SHALL VISIT THE SITE TO VERIFY AND BE FULLY AWARE OF EXISTING CONDITIONS PRIOR TO START OF WORK. CONTRACTOR SHALL IDENTIFY ALL EXISTING ITEMS OF WORK SCHEDULED TO REMAIN OR SALVAGED FOR REUSE.
- . ALL DEMOLITION WORK SHALL BE PERFORMED IN ACCORDANCE WITH STATE AND LOCAL REGULATIONS. CONTRACTOR SHALL SECURE AND PAY FOR ALL REQUIRED DEMOLITION PERMITS. THE CONTRACTOR SHALL MAKE ALL NECESSARY CONSTRUCTION NOTIFICATIONS AND APPLY FOR AND OBTAIN ALL NECESSARY CONSTRUCTION PERMITS.
- COORDINATE ALL DEMOLITION OPERATIONS WITH OWNER FOR SHUTDOWN PERIODS AND SEQUENCE OF WORK. ARRANGE WITH OWNER AND/OR APPROPRIATE UTILITIES FOR SERVICE SHUTOFFS BEFORE BEGINNING DEMOLITION OPERATIONS. PROVIDE TEMPORARY DUST PARTITIONS, BARRICADES AND PROTECTIVE ENCLOSURES REQUIRED TO PROPERLY SECURE, ISOLATE AND WEATHERPROOF AREAS OF WORK AND EXISTING AREAS AND ELEMENTS TO REMAIN. THE CONTRACTOR SHALL PERFORM THE WORK OF THIS CONTRACT IN A MANNER THAT CAUSES NO DISRUPTION TO THE CONTINUOUS OCCUPATION OF THE BUILDING AND SITE FOR THEIR INTENDED PURPOSE.
- 4. REMOVE ALL DEMOLISHED MATERIALS IN ACCORDANCE WITH LOCAL REGULATIONS.
- 5. IT IS NOT THE INTENT TO SHOW EVERY PIECE OR ITEM TO BE REMOVED IN DEMOLITION WORK. PLUMBING, ELECTRICAL AND OTHER WORK RELATED TO A WALL, OR AREA SCHEDULED FOR DEMOLITION AND REMOVAL, SHALL BE PERFORMED WHETHER NOTED OR NOT.
- 6. THE EXTENT OF ALL SPECIFIC DEMOLITION WORK SHALL BE COORDINATED WITH CONTRACT DOCUMENTS.
- CONTRACTOR TO PATCH/REPAIR/REFINISH, AS REQUIRED, ALL SURFACES EXPOSED BY DEMOLITION WORK WITH MATERIALS AND METHODS TO MATCH FINISH AND MAKE FLUSH WITH EXISTING ADJACENT SURFACES. WORK SHALL INCLUDE ALL LABOR AND MATERIALS ON ALL SURFACES REQUIRED TO RENDER SUBSTRATES ACCEPTABLE TO RECEIVE NEW FINISHES SPECIFIED IN ACCORDANCE WITH MANUFACTURER'S WRITTEN RECOMMENDATIONS.
- . TERMINATE, CAP, AND REMOVE ALL ABANDONED ELECTRICAL, PLUMBING, MECHANICAL AND FIRE PROTECTION ITEMS BACK TO ITS SOURCE. REFER TO MEP DRAWINGS FOR ADDITIONAL
- 9. WHERE EXISTING FINISHES ARE INDICATED TO REMAIN AS BASE MATERIAL SURFACES FOR INSTALLATION OF NEW FINISHES, REMOVE ALL PROJECTIONS AND VOIDS AND SECURE OR REMOVE AND REPLACE ANY EXISTING LOOSE OR OTHERWISE UNSUITABLE SUBSTRATE
- 10. REFER TO VARIOUS DISCIPLINE DEMOLITION PLANS FOR ADDITIONAL INFORMATION.
- 11. CONTRACTOR TO PROTECT ALL ITEMS TO REMAIN DURING DEMOLITION. ALL ITEMS DAMAGED DURING DEMOLITION ARE TO BE REPLACED AT NO EXPENSE TO THE OWNER.
- 12. CONTRACTOR IS RESPONSIBLE FOR MEANS & METHODS IN A SAFE MANNER FOR ALL DEMOLITION
- 13. ASBESTOS CONTAINING MATERIALS ARE PRESENT AND ARE TO BE DEMOLISHED UNDER THIS PROJECT. REFER TO SPECIFICATION, DIV 2, FOR HAZARDOUS MATERIALS AND QUANTITIES.
- 14. THE CONTRACTOR SHALL BE SOLELY RESPONSIBLE FOR JOB SITE SAFETY AND ALL CONSTRUCTION MEANS AND METHODS. PRIOR TO BEGINNING CONSTRUCTION, CONTRACTOR SHALL WALK THE SITE WITH THE ARCHITECT TO GAIN A THOROUGH UNDERSTANDING OF THE PROJECT, INCLUDING ANY SPECIAL CONDITIONS AND CONSTRAINTS.
- 15. SITE PREPARATION AND DEMOLITION SHALL INCLUDE THOSE AREAS WITHIN THE LIMIT OF WORK LINE AS SHOWN ON THIS CONTRACT.
- 16. THE CONTRACTOR SHALL COMPLY WITH MASSACHUSETTS GENERAL LAWS CHAPTER 82, SECTION 40A, AS AMENDED, WHICH STATES THAT NO ONE MAY EXCAVATE IN THE COMMONWEALTH OF MASSACHUSETTS EXCEPT IN AN EMERGENCY WITHOUT 72 HOURS NOTICE, EXCLUSIVE OF SATURDAYS, SUNDAYS AND LEGAL HOLIDAYS, TO NATURAL GAS PIPELINE COMPANIES, AND MUNICIPAL UTILITY DEPARTMENTS THAT SUPPLY GAS, ELECTRICITY, TELEPHONE, OR CABLE TELEVISION SERVICE IN OR TO THE CITY OR TOWN WHERE THE EXCAVATION IS TO BE MADE. THE CONTRACTOR SHALL CALL "DIG SAFE" AT 1-888-DIG-SAFE.
- 17. IT IS THE CONTRACTOR'S RESPONSIBILITY TO VERIFY ALL CONDITIONS IN THE FIELD AND REPORT DISCREPANCIES BETWEEN PLANS AND ACTUAL CONDITIONS TO THE OWNER OR OWNER'S REPRESENTATION IMMEDIATELY.
- 18. THE CONTRACTOR IS RESPONSIBLE TO COORDINATE THE LOCATION OF UNDERGROUND UTILITIES SHOWN ON CIVIL PLANS AND SHALL CONTACT THE PROPER LOCAL AUTHORITIES OR RESPECTIVE UTILITY COMPANY TO CONFIRM THE LOCATION OF ALL EXISTING UTILITIES BEFORE COMMENCING WORK. ANY DAMAGE DUE TO FAILURE OF THE CONTRACTOR TO CONTACT THE PROPER AUTHORITIES SHALL BE BORNE BY THE CONTRACTOR.
- 19. CARE SHOULD BE TAKEN IN ALL EXCAVATIONS DUE TO POSSIBLE EXISTENCE OF UNRECORDED
- 20. EXCAVATION REQUIRED WITHIN PROXIMITY OF EXISTING UTILITY LINES SHALL BE DONE BY HAND. CONTRACTOR SHALL REPAIR ANY DAMAGE TO EXISTING UTILITY LINES OR STRUCTURES INCURRED DURING CONSTRUCTION OPERATIONS.
- 21. REMOVE AND STOCKPILE ALL EXISTING SITE LIGHTS, BENCHES, TRASH RECEPTACLES, TRAFFIC SINGES, GRANITE CURBS, AND OTHER SITE IMPROVEMENTS WITHIN LIMIT OF WORK LINE UNLESS OTHERWISE NOTED.
- 22. ANY AREA OUTSIDE THE LIMIT OF WORK THAT IS DISTURBED SHALL BE RESTORED TO ITS ORIGINAL CONDITION AT NO ADDITIONAL COST TO THE OWNER.
- 23. CONSULT ALL OF THE DRAWINGS AND SPECIFICATIONS FOR COORDINATION REQUIREMENTS BEFORE COMMENCING DEMOLITION. CONTRACTOR SHALL PERFORM HAZARDOUS BUILDING MATERIALS ABATEMENT AS REQUIRED BY THE SPECIFICATIONS PRIOR TO THE START OF ANY
- 24. CONTRACTOR SHALL SUPPLY AND MAINTAIN FOR THE DURATION OF DEMOLITION ALL NECESSARY DEVICES FOR EROSION, SEDIMENTATION AND DUST CONTROL, ETC.
- 25. ALL ITEMS REQUIRING REMOVAL SHALL BE REMOVED TO FULL DEPTH TO INCLUDE BASE MATERIAL AND FOOTINGS OR FOUNDATIONS AS APPLICABLE, AND LEGALLY DISPOSED OF OFF-SITE BY CONTRACTOR.
- 26. TREE AND SHRUB PROTECTION SHALL BE PER SPECIFICATIONS.
- 27. BEFORE ANY TREES OR SHRUBS ARE REMOVED, THE CONTRACTOR SHALL ARRANGE A CONFERENCE ON THE SITE WITH THE OWNER OR OWNER'S REPRESENTATIVE TO IDENTIFY TREES AND SHRUBS THAT ARE TO BE REMOVED, AS WELL AS THOSE WHICH ARE TO BE PROTECTED. DO NO CLEARING WITHOUT A CLEAR UNDERSTANDING OF EXISTING CONDITIONS TO BE PRESERVED.

COTTAGE RELOCATION AND UPGRADE 13 WALSH WAY, TRURO - MA 02655

TOWN OF TRURO, MA

Weston & Sampson Engineers, Inc. 55 Walkers Brook Drive, Suite 100 Reading, MA 01867

www.westonandsampson.com

978.532.1900 800.SAMPSON

Consultants:							
Revisi	ons:						
No.	Date	Description					

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PROJECT STATUS

Scale: Not Stated Key Plan:

TO CREATE KEYPLAN, EDIT THE

KEYPLAN FAMILY WITHIN THE TITLEBLOCK FAMILY AND INSERT CAD




07/11/2023 Drawn By: Reviewed By: Approved By:

W&S Project No.: ENG00-00000

W&S File No.: XXX

Drawing Title:

13 WALSH WAY -**DEMOLITION FLOOR**

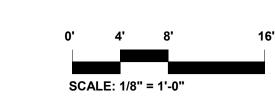

WIRING, LIGHTING, ETC.... 11' - 9" 7' - 6" 10' - 0" 6' - 3" 4' - 6" <u>Studio</u>

10' - 0"

BEDROOM

16' - 0"

30' - 0"

14' - 0"

2 EXISTING OVERALL FLOOR PLAN
1/4" = 1'-0" 1/ A202

SPECIFIC DEMOLITION NOTES:


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- ELECTRICAL FIXTURES, CONDUITS, WIRING, ETC... PLUMBING FIXTURES, PANELS, PIPING, ETC...
- FIRE SUPRESSION SYSTEMS, PIPING, CONTROLS, ETC...
- EXTERIOR ELECTRICAL EQUIPMENT INCLUDING TRANSFORMERS, PANELS, CONDUITS,
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- TERMINATE, CAP, AND REMOVE ALL ABANDONED ELECTRICAL, PLUMBING, MECHANICAL AND FIRE PROTECTION ITEMS BACK TO ITS SOURCE. REFER TO MEP DRAWINGS FOR ADDITIONAL INFORMATION.
- 9. WHERE EXISTING FINISHES ARE INDICATED TO REMAIN AS BASE MATERIAL SURFACES FOR INSTALLATION OF NEW FINISHES, REMOVE ALL PROJECTIONS AND VOIDS AND SECURE OR REMOVE AND REPLACE ANY EXISTING LOOSE OR OTHERWISE UNSUITABLE SUBSTRATE
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- 1. CONTRACTOR TO PROTECT ALL ITEMS TO REMAIN DURING DEMOLITION. ALL ITEMS DAMAGED DURING DEMOLITION ARE TO BE REPLACED AT NO EXPENSE TO THE OWNER.
- 12. CONTRACTOR IS RESPONSIBLE FOR MEANS & METHODS IN A SAFE MANNER FOR ALL DEMOLITION
- 3. ASBESTOS CONTAINING MATERIALS ARE PRESENT AND ARE TO BE DEMOLISHED UNDER THIS PROJECT. REFER TO SPECIFICATION, DIV 2, FOR HAZARDOUS MATERIALS AND QUANTITIES.
- 14. THE CONTRACTOR SHALL BE SOLELY RESPONSIBLE FOR JOB SITE SAFETY AND ALL CONSTRUCTION MEANS AND METHODS. PRIOR TO BEGINNING CONSTRUCTION, CONTRACTOR SHALL WALK THE SITE WITH THE ARCHITECT TO GAIN A THOROUGH UNDERSTANDING OF THE PROJECT, INCLUDING ANY SPECIAL CONDITIONS AND CONSTRAINTS.
- 15. SITE PREPARATION AND DEMOLITION SHALL INCLUDE THOSE AREAS WITHIN THE LIMIT OF WORK LINE AS SHOWN ON THIS CONTRACT.
- 16. THE CONTRACTOR SHALL COMPLY WITH MASSACHUSETTS GENERAL LAWS CHAPTER 82, SECTION 40A. AS AMENDED. WHICH STATES THAT NO ONE MAY EXCAVATE IN THE COMMONWEALTH OF MASSACHUSETTS EXCEPT IN AN EMERGENCY WITHOUT 72 HOURS NOTICE, EXCLUSIVE OF SATURDAYS, SUNDAYS AND LEGAL HOLIDAYS, TO NATURAL GAS PIPELINE COMPANIES, AND MUNICIPAL UTILITY DEPARTMENTS THAT SUPPLY GAS, ELECTRICITY, TELEPHONE, OR CABLE TELEVISION SERVICE IN OR TO THE CITY OR TOWN WHERE THE EXCAVATION IS TO BE MADE. THE CONTRACTOR SHALL CALL "DIG SAFE" AT 1-888-DIG-SAFE.
- 17. IT IS THE CONTRACTOR'S RESPONSIBILITY TO VERIFY ALL CONDITIONS IN THE FIELD AND REPORT DISCREPANCIES BETWEEN PLANS AND ACTUAL CONDITIONS TO THE OWNER OR OWNER'S REPRESENTATION IMMEDIATELY.
- 18. THE CONTRACTOR IS RESPONSIBLE TO COORDINATE THE LOCATION OF UNDERGROUND UTILITIES SHOWN ON CIVIL PLANS AND SHALL CONTACT THE PROPER LOCAL AUTHORITIES OR RESPECTIVE UTILITY COMPANY TO CONFIRM THE LOCATION OF ALL EXISTING UTILITIES BEFORE COMMENCING WORK. ANY DAMAGE DUE TO FAILURE OF THE CONTRACTOR TO CONTACT THE PROPER AUTHORITIES SHALL BE BORNE BY THE CONTRACTOR.
- 19. CARE SHOULD BE TAKEN IN ALL EXCAVATIONS DUE TO POSSIBLE EXISTENCE OF UNRECORDED UTILITY LINES.
- 20. EXCAVATION REQUIRED WITHIN PROXIMITY OF EXISTING UTILITY LINES SHALL BE DONE BY HAND. CONTRACTOR SHALL REPAIR ANY DAMAGE TO EXISTING UTILITY LINES OR STRUCTURES INCURRED DURING CONSTRUCTION OPERATIONS.
- 21. REMOVE AND STOCKPILE ALL EXISTING SITE LIGHTS, BENCHES, TRASH RECEPTACLES, TRAFFIC SINGES, GRANITE CURBS, AND OTHER SITE IMPROVEMENTS WITHIN LIMIT OF WORK LINE UNLESS OTHERWISE NOTED.
- 22. ANY AREA OUTSIDE THE LIMIT OF WORK THAT IS DISTURBED SHALL BE RESTORED TO ITS ORIGINAL CONDITION AT NO ADDITIONAL COST TO THE OWNER.
- 23. CONSULT ALL OF THE DRAWINGS AND SPECIFICATIONS FOR COORDINATION REQUIREMENTS BEFORE COMMENCING DEMOLITION. CONTRACTOR SHALL PERFORM HAZARDOUS BUILDING MATERIALS ABATEMENT AS REQUIRED BY THE SPECIFICATIONS PRIOR TO THE START OF ANY
- 24. CONTRACTOR SHALL SUPPLY AND MAINTAIN FOR THE DURATION OF DEMOLITION ALL NECESSARY DEVICES FOR EROSION, SEDIMENTATION AND DUST CONTROL, ETC.
- 25. ALL ITEMS REQUIRING REMOVAL SHALL BE REMOVED TO FULL DEPTH TO INCLUDE BASE MATERIAL AND FOOTINGS OR FOUNDATIONS AS APPLICABLE, AND LEGALLY DISPOSED OF OFF-SITE BY CONTRACTOR.
- 26. TREE AND SHRUB PROTECTION SHALL BE PER SPECIFICATIONS.
- 27. BEFORE ANY TREES OR SHRUBS ARE REMOVED, THE CONTRACTOR SHALL ARRANGE A CONFERENCE ON THE SITE WITH THE OWNER OR OWNER'S REPRESENTATIVE TO IDENTIFY TREES AND SHRUBS THAT ARE TO BE REMOVED, AS WELL AS THOSE WHICH ARE TO BE PROTECTED. DO NO CLEARING WITHOUT A CLEAR UNDERSTANDING OF EXISTING CONDITIONS TO BE PRESERVED.

SCALE: 1/8" = 1'-0"

COTTAGE RELOCATION & UPGRADE 127 S PAMET RD, TRURO - MA 02655

TOWN OF TRURO, MA

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Reading, MA 01867

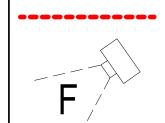110110101						
No.	Date	Description				
COA						

PROJECT STATUS

Scale: NFSndicated

TO CREATE KEYPLAN, EDIT THE **KEYPLAN FAMILY WITHIN THE** TITLEBLOCK FAMILY AND INSERT CAD TO TRACE OVER.




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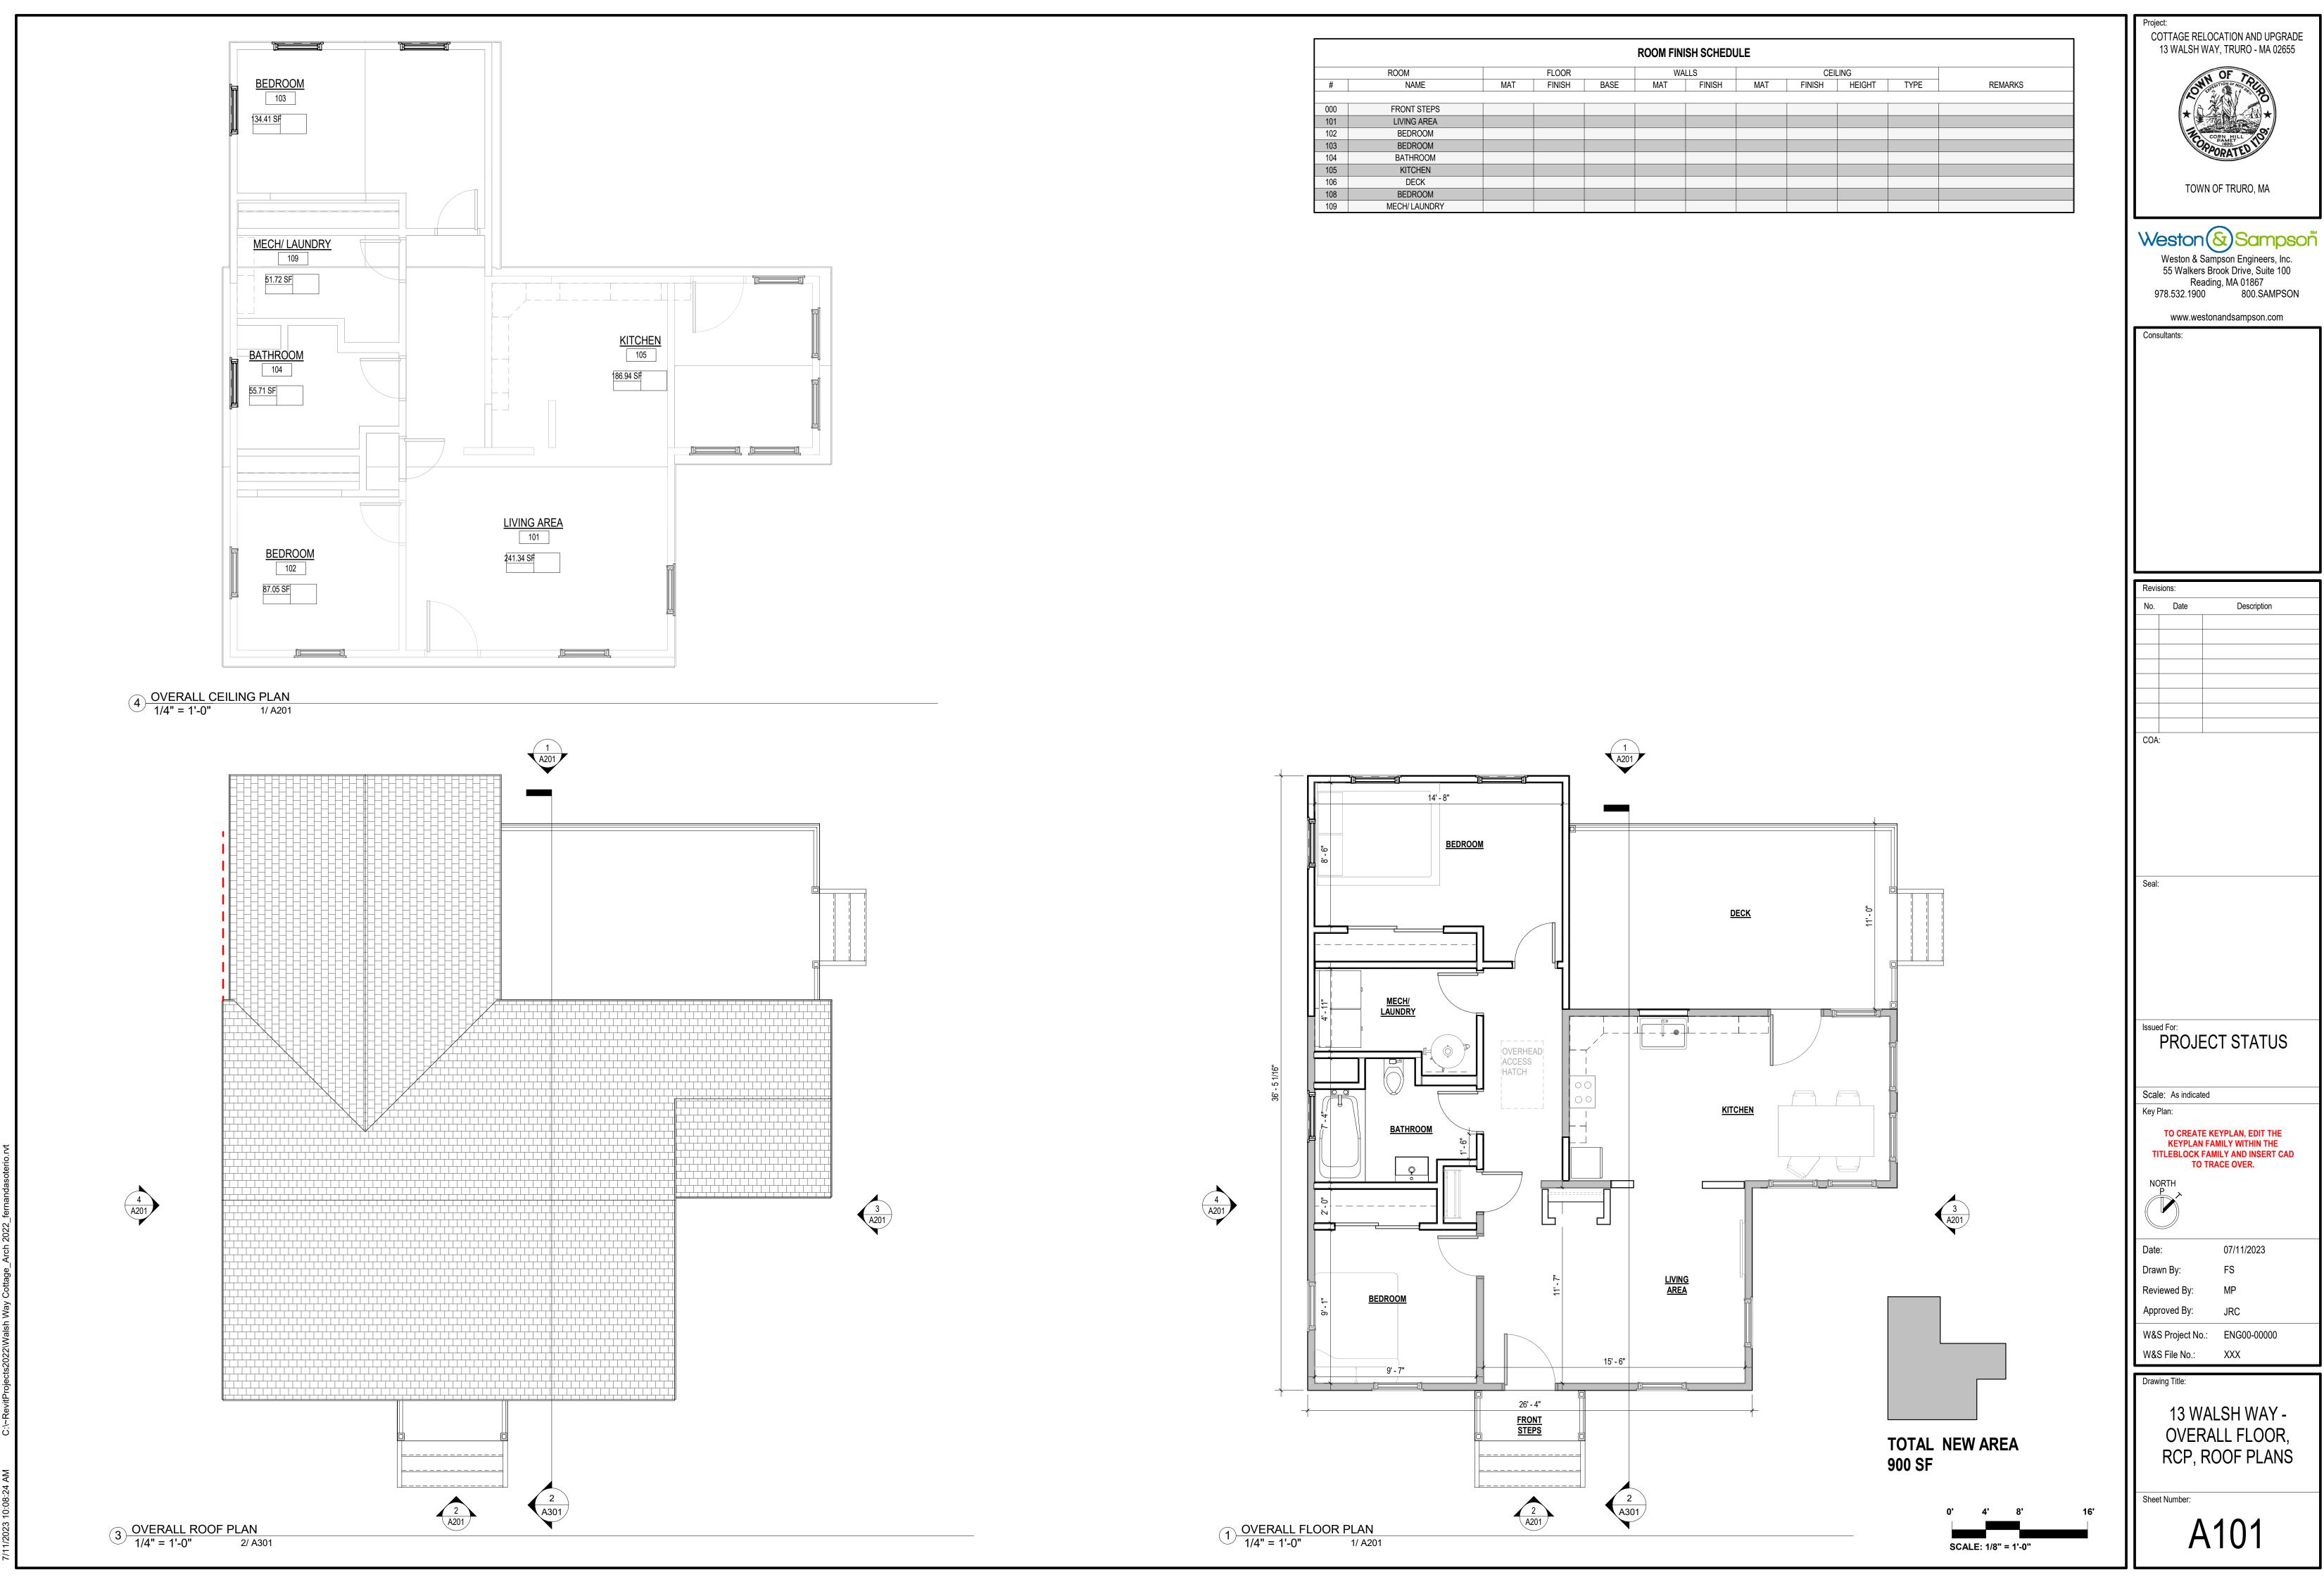
W&S Project No.: ENG22-1122 W&S File No.:

127 S PAMENT RD -**DEMOLITION FLOOR**

PLANS

Drawing Title:



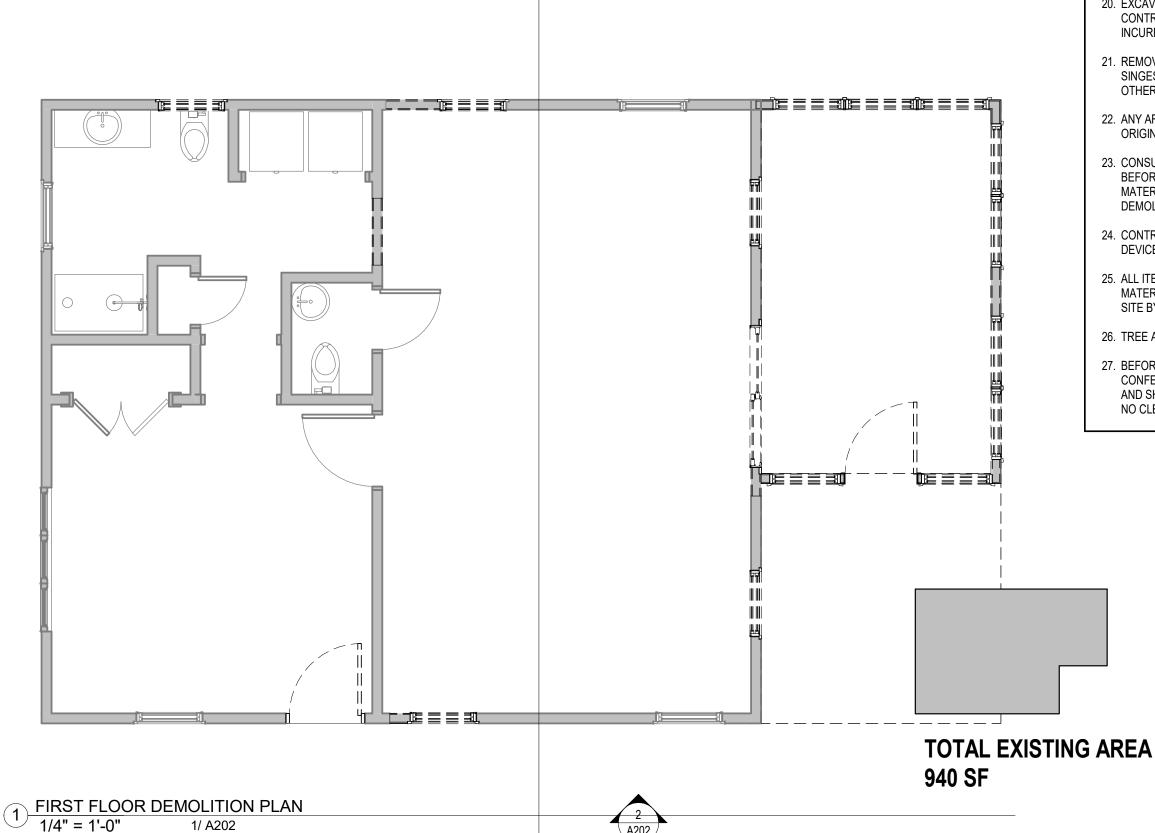


COTTAGE RELOCATION AND UPGRADE 13 WALSH WAY, TRURO - MA 02655 TOWN OF TRURO, MA


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No.		
	Date	Description
COA:		
Seal:		

PROJECT STATUS

13 WALSH WAY -OVERALL FLOOR, RCP, ROOF PLANS



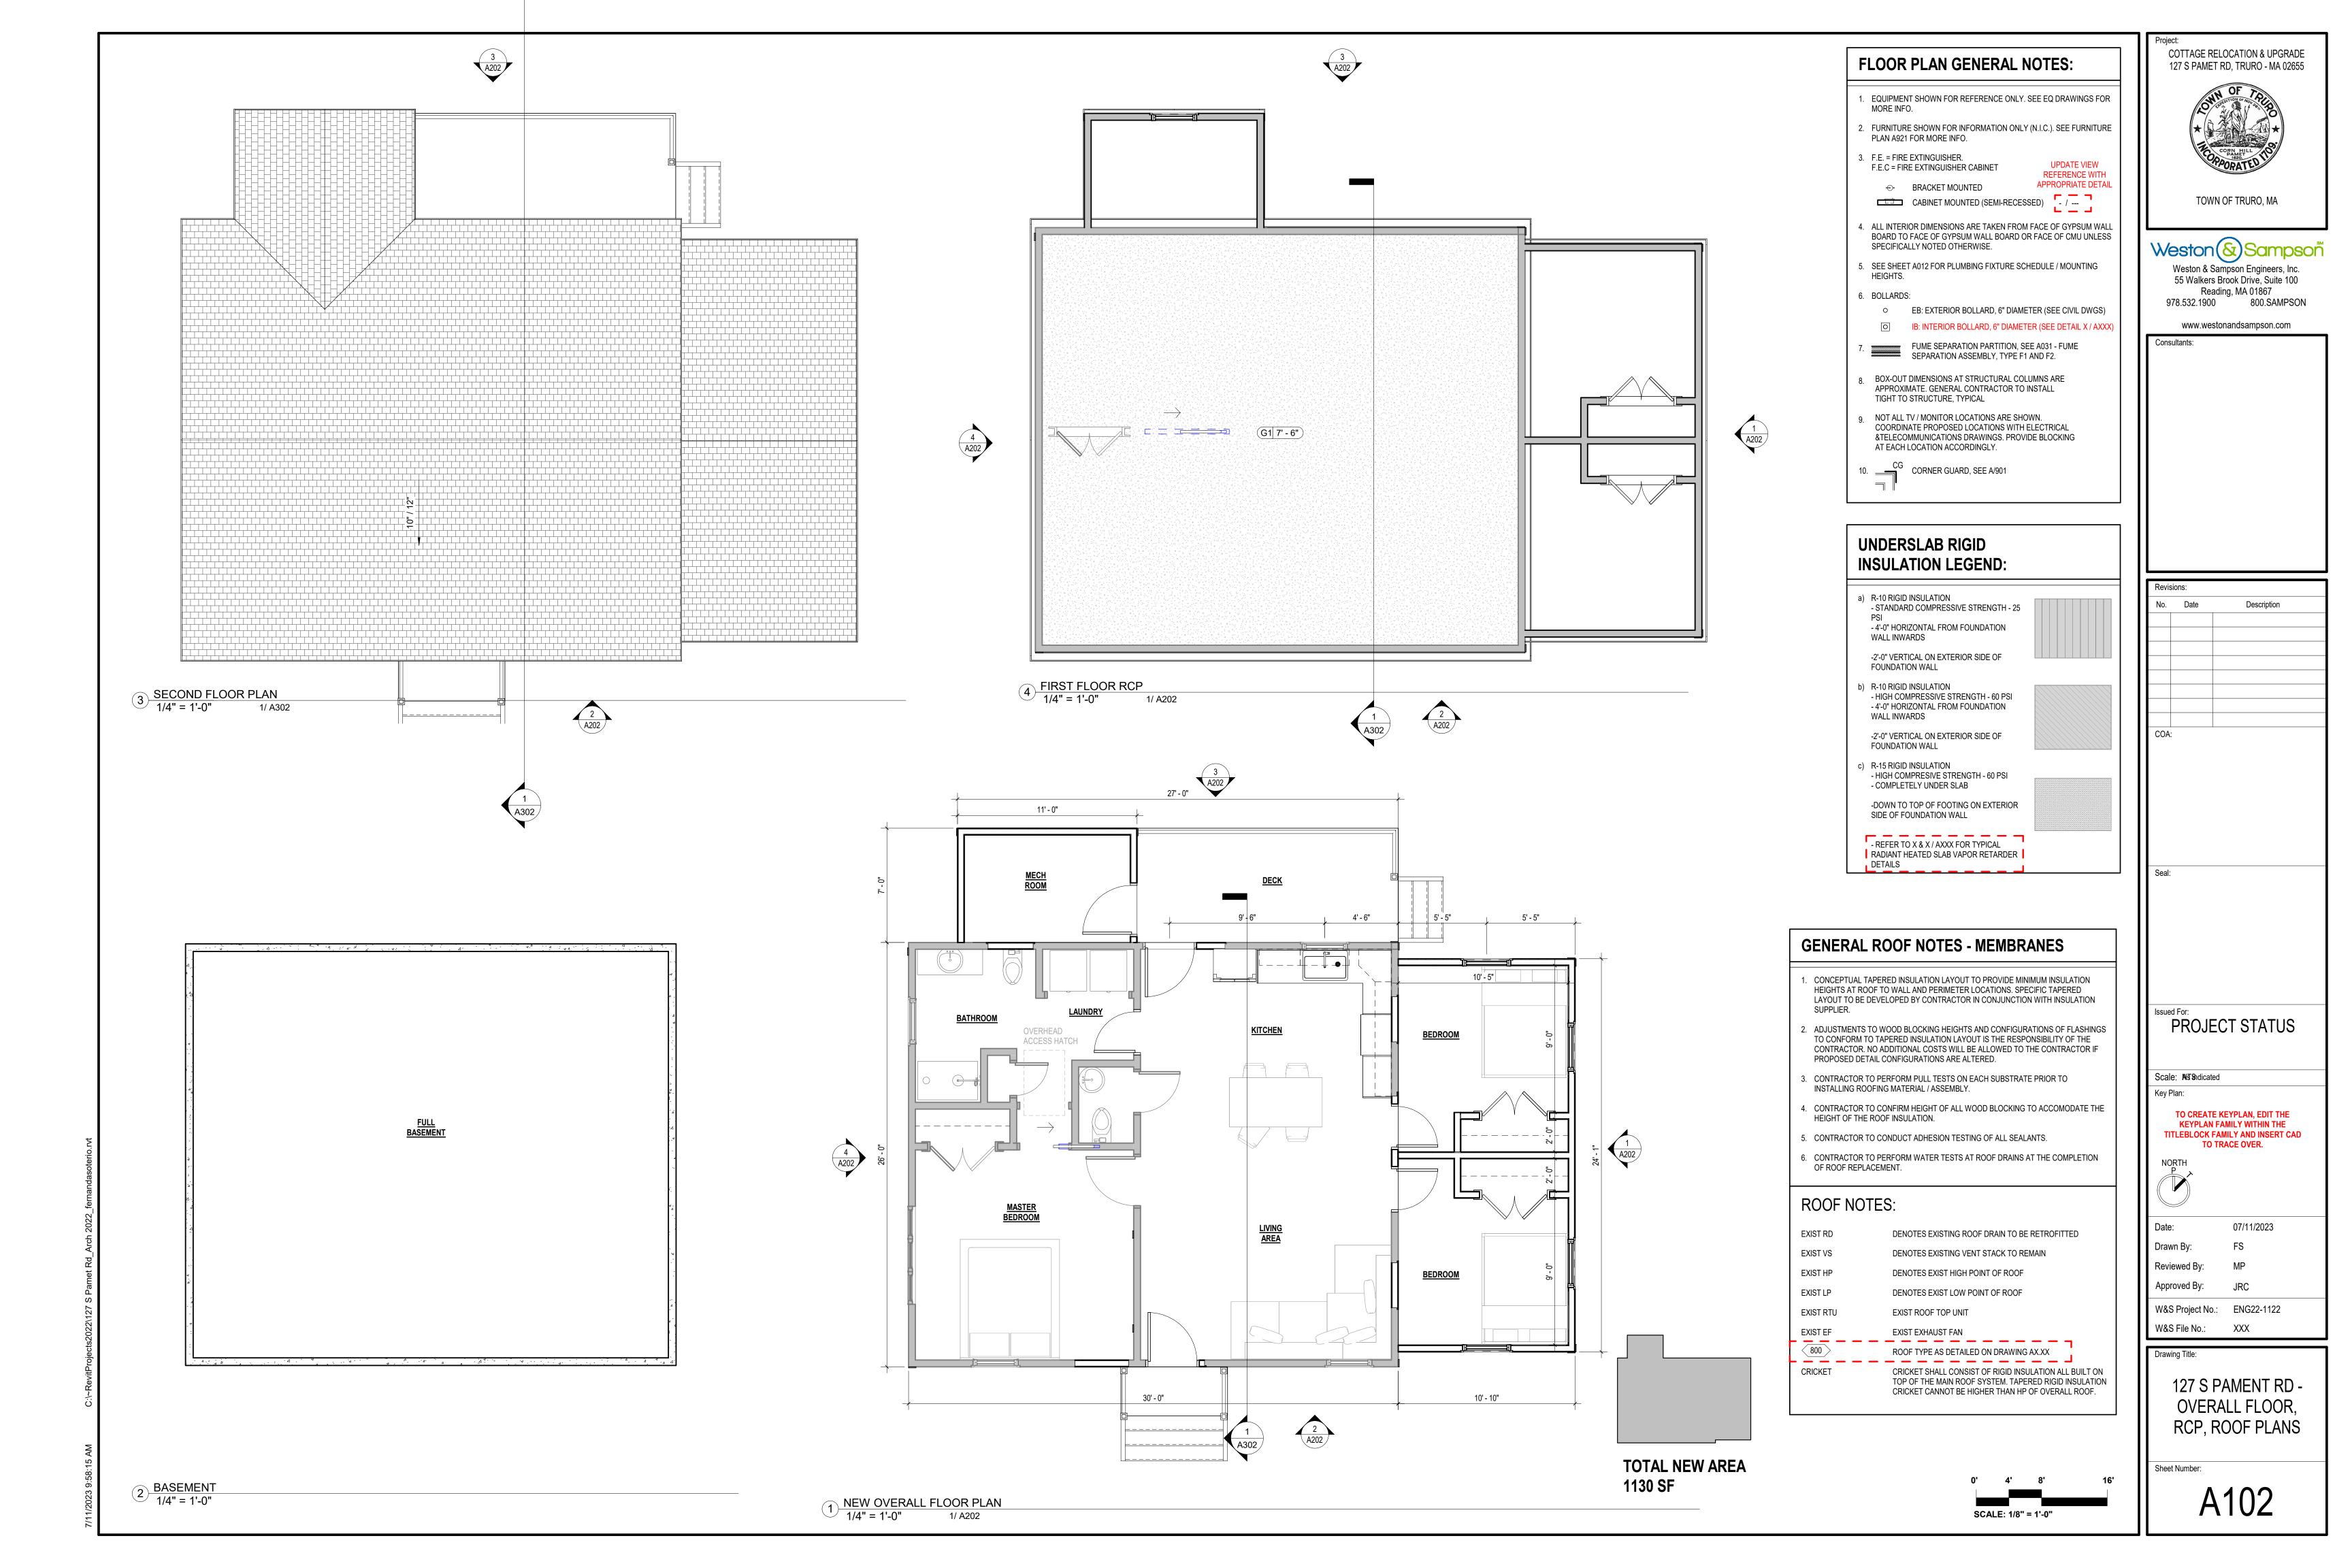

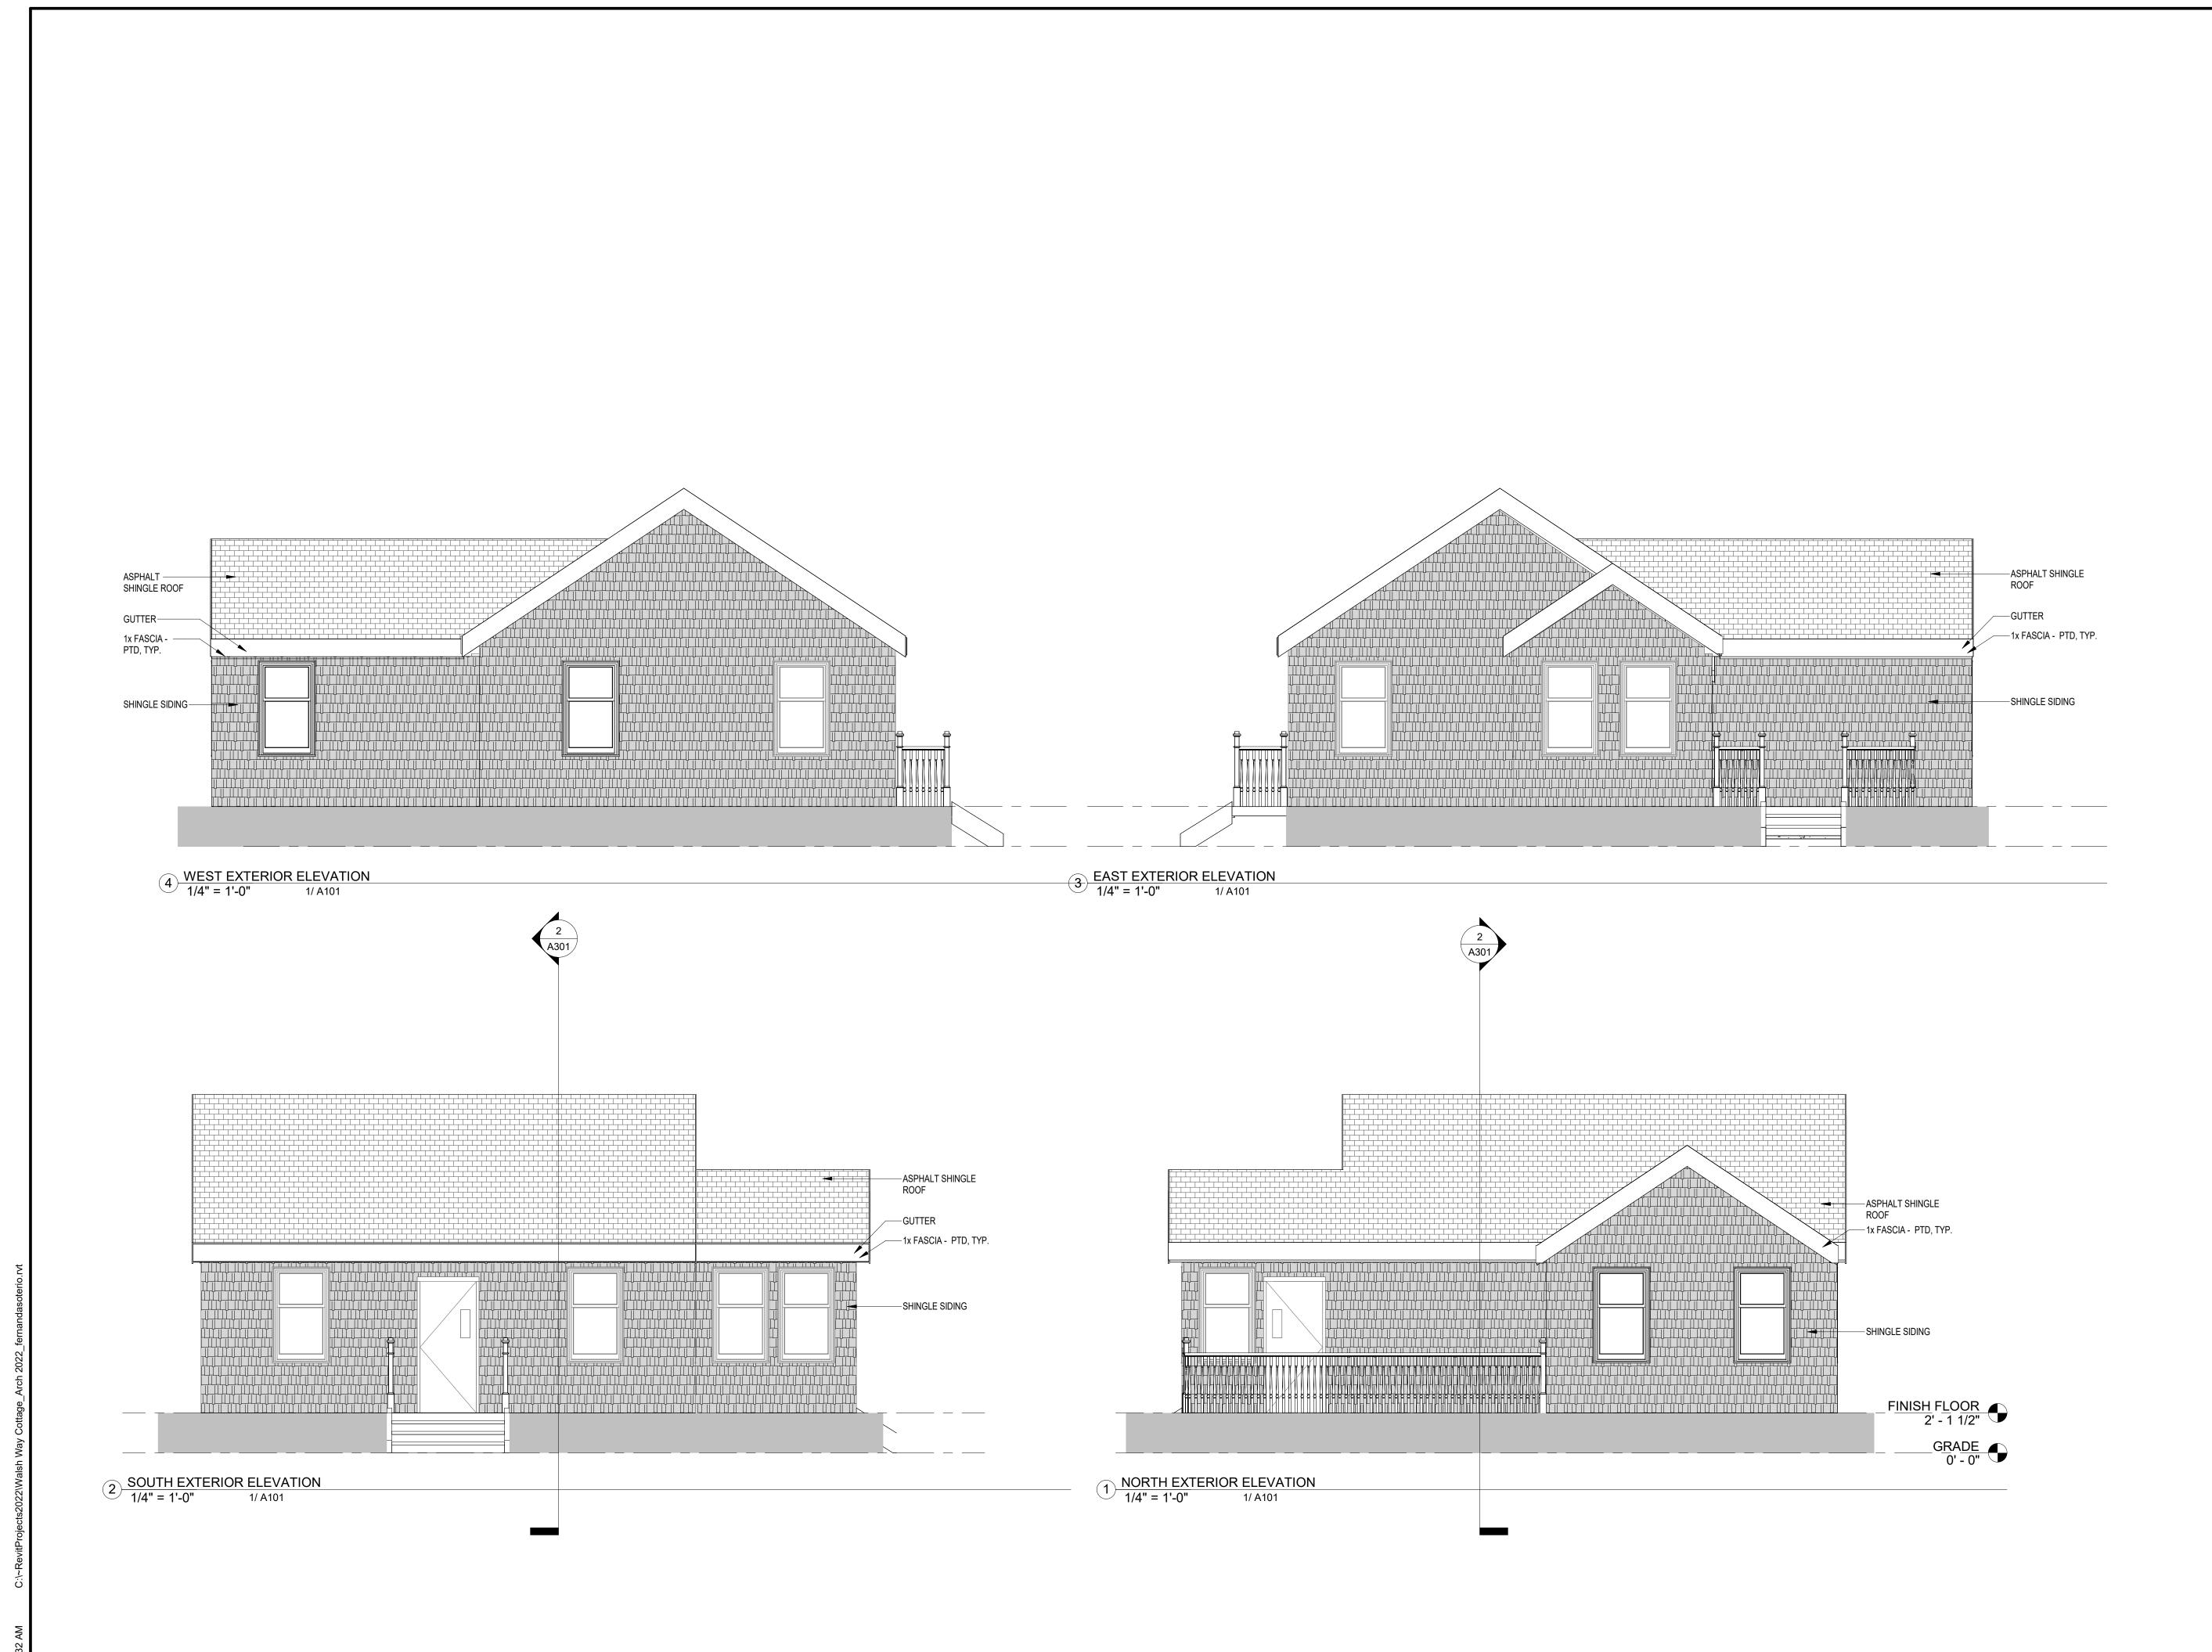COTTAGE RELOCATION AND UPGRADE 13 WALSH WAY, TRURO - MA 02655 TOWN OF TRURO, MA Weston & Sampson Engineers, Inc. 55 Walkers Brook Drive, Suite 100 Reading, MA 01867 978.532.1900 800.SAMPSON www.westonandsampson.com Description COA: PROJECT STATUS Scale: N745 = 1'-0" Key Plan: TO CREATE KEYPLAN, EDIT THE KEYPLAN FAMILY WITHIN THE TITLEBLOCK FAMILY AND INSERT CAD TO TRACE OVER. 07/11/2023 Date: Drawn By:

Drawn By: FS

Reviewed By: MP

Approved By: JRC

W&S Project No.: ENG00-00000
W&S File No.: XXX

Drawing Title:

13 WALSH WAY -OVERALL ELEVATIONS


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0' 4' 8'

SCALE: 1/8" = 1'-0"








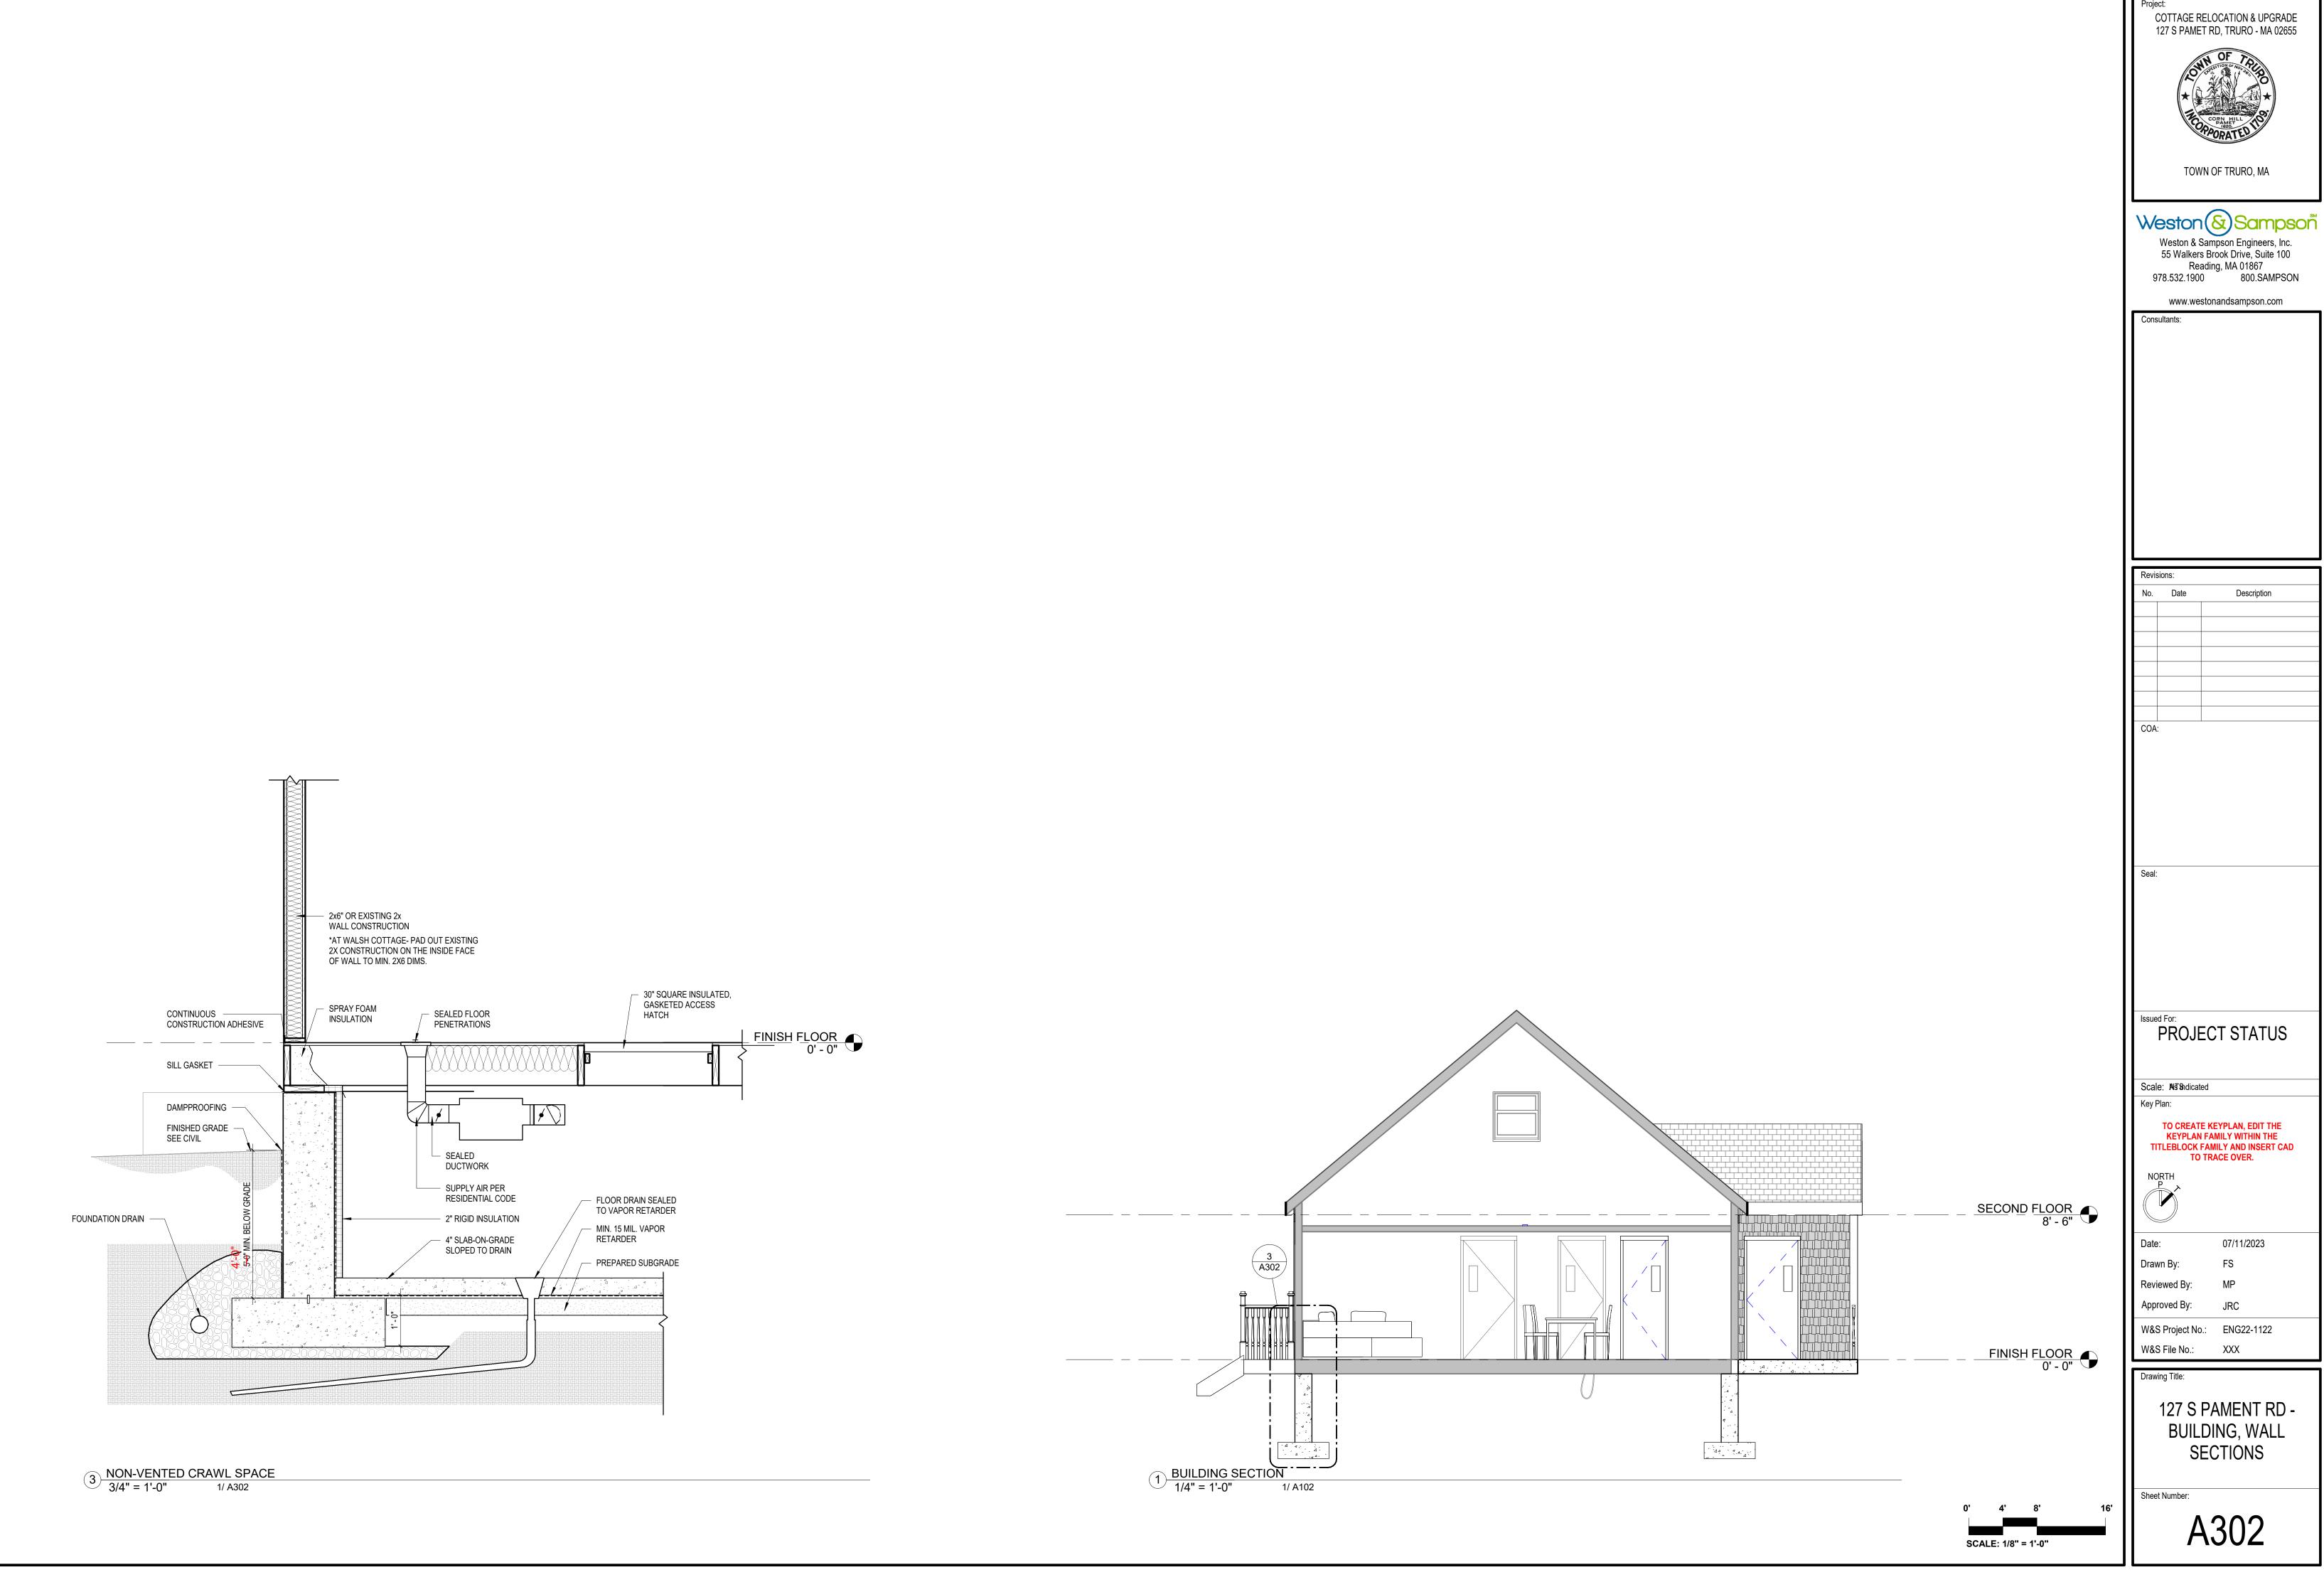

NOTE: 3D VIEWS ARE PROVIDED FOR REFERENCE ONLY.
REFER TO PLANS, ELEVATIONS, SECTIONS, DETAILS AND SCHEDULES FOR BUILDING REQUIREMENTS.

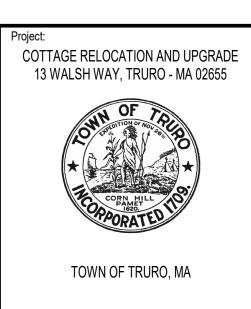

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No.	Date	Description			
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PROJECT STATU

Scale: N785 = 1'-0"

Key Plan:

TO CREATE KEYPLAN, EDIT THE
KEYPLAN FAMILY WITHIN THE
TITLEBLOCK FAMILY AND INSERT CAD
TO TRACE OVER.



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Drawn By:	FS
Reviewed By:	MP
Approved By:	JRC


W&S Project No.: ENG00-00000
W&S File No.: XXX

Drawing Title:

3D VIEWS

Sheet Number:

A231

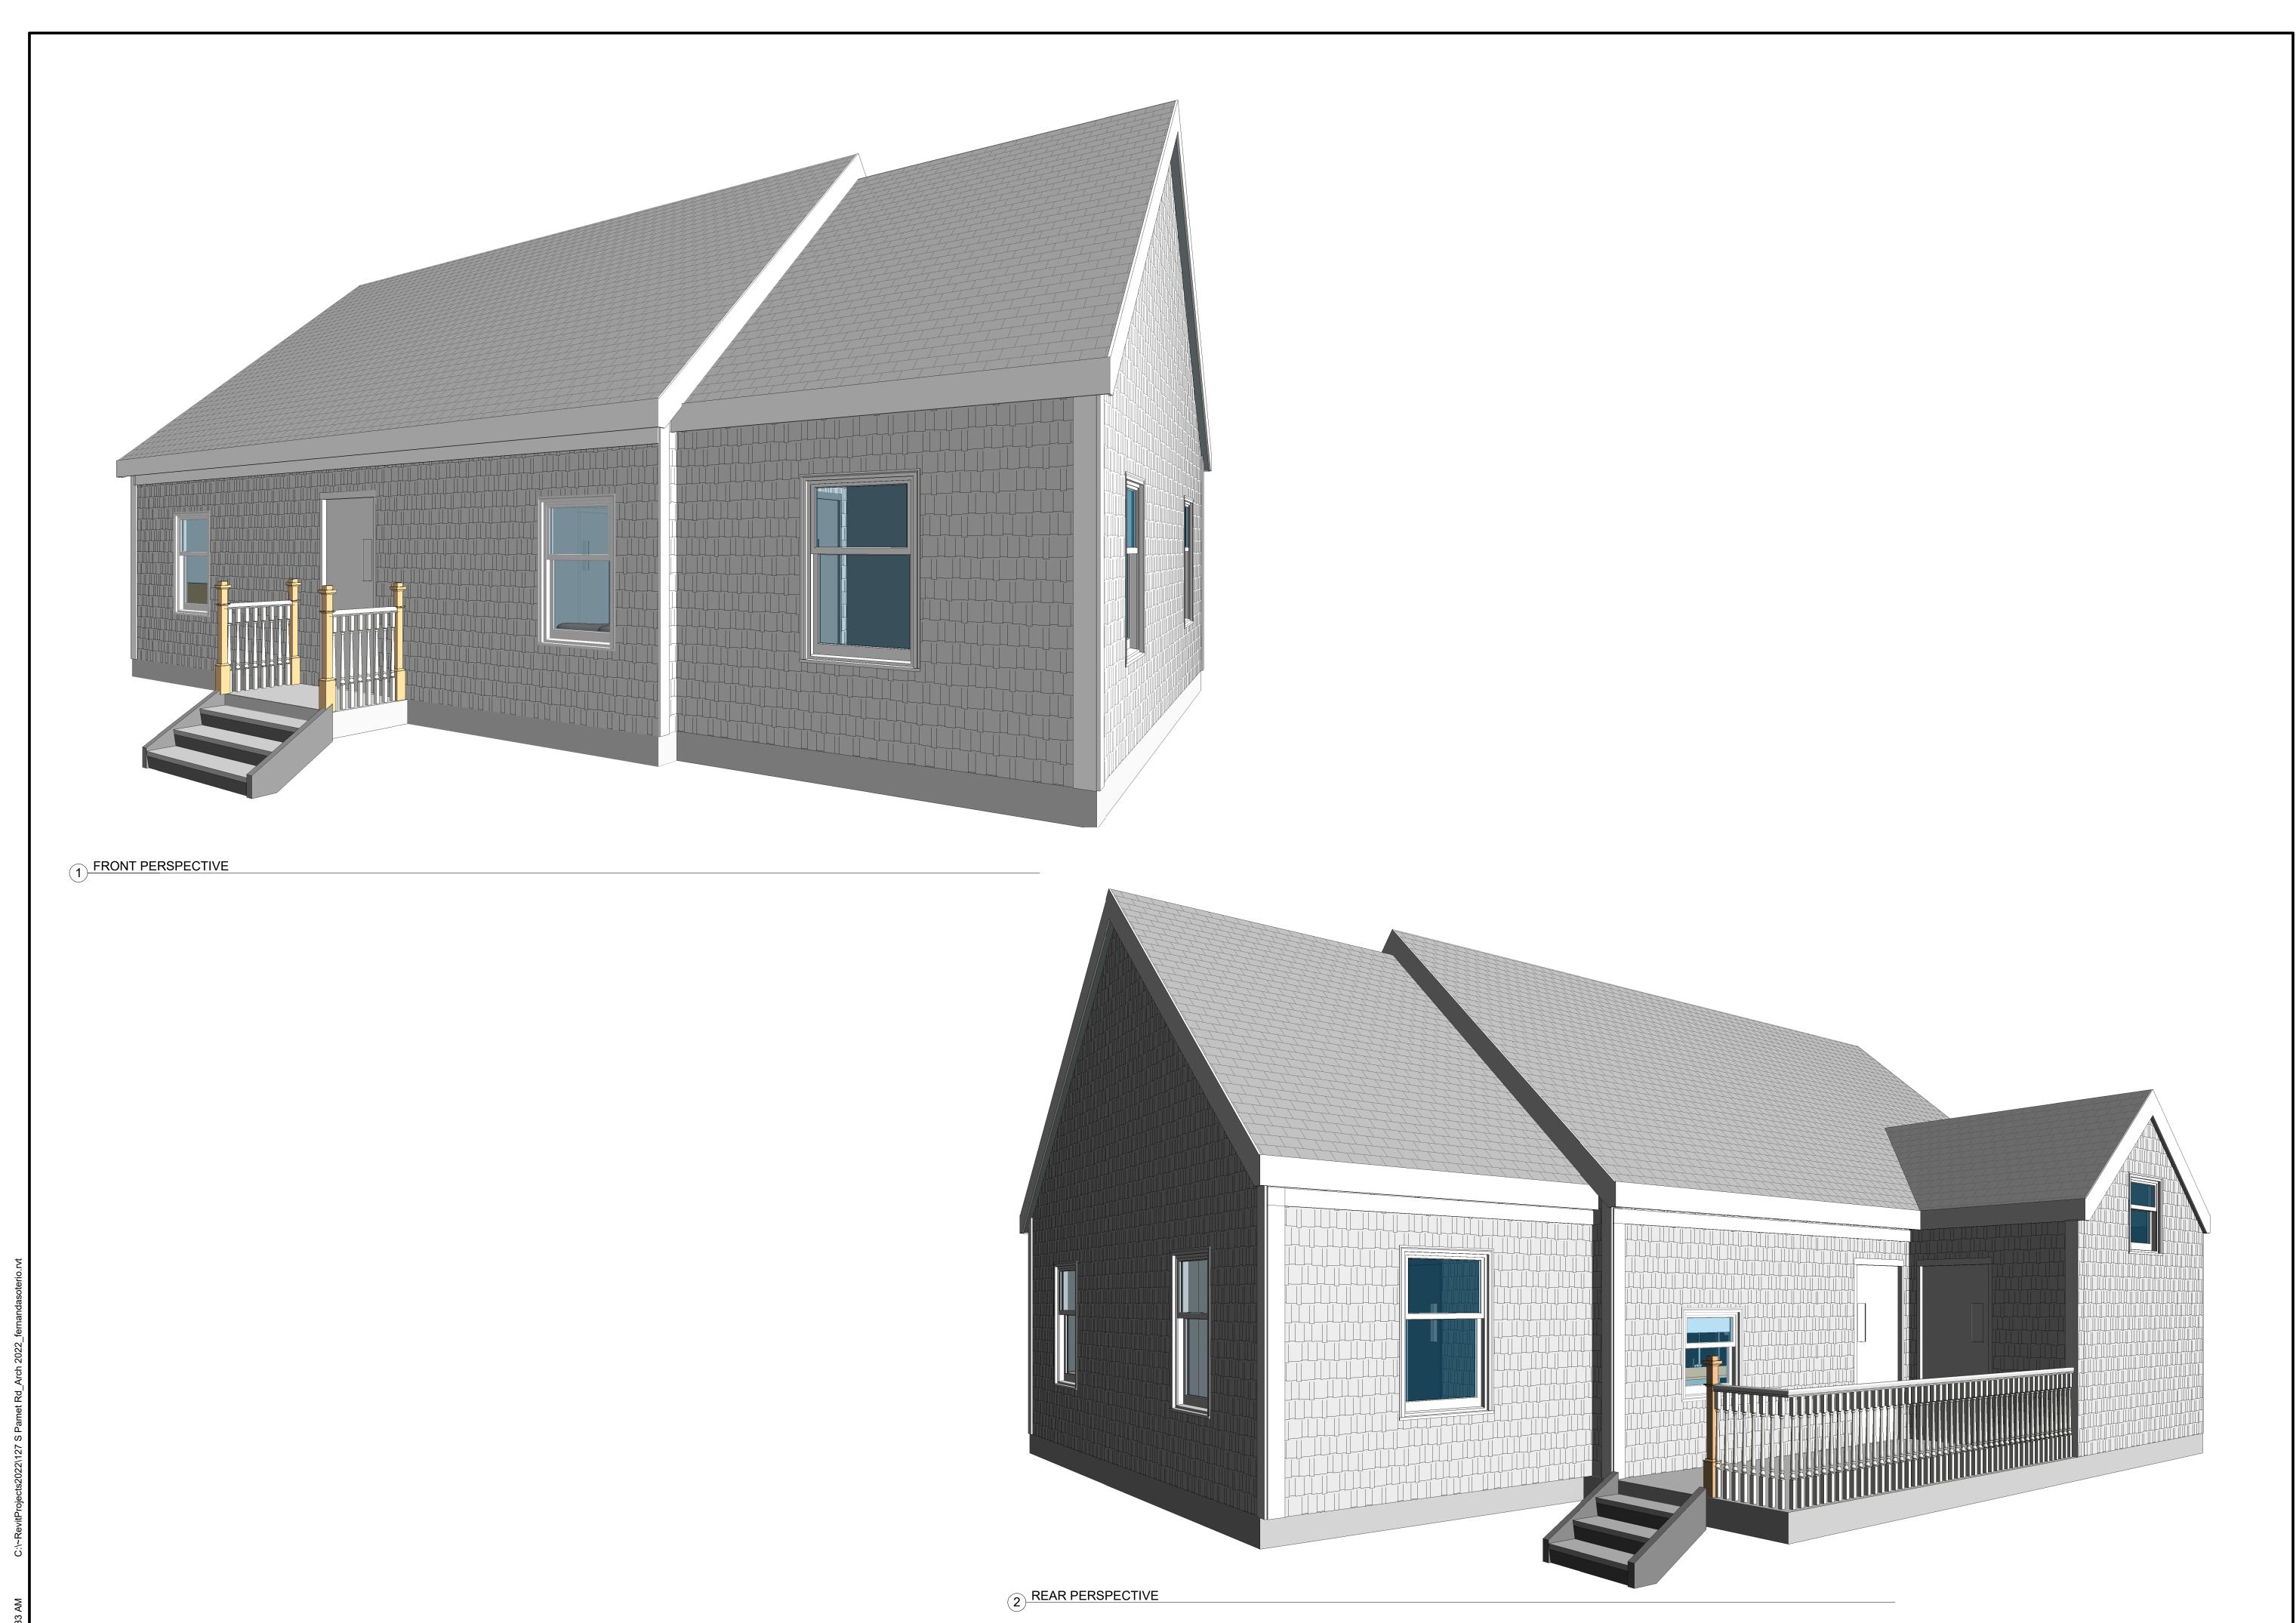

Project:

COTTAGE RELOCATION & UPGRADE
127 S PAMET RD, TRURO - MA 02655

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No.	Date	Description
COA	:	

Seal:

ssued For:	
PROJECT STATUS	

Scale: N785 = 1'-0"

Key Plan:

TO CREATE KEYPLAN, EDIT THE
KEYPLAN FAMILY WITHIN THE
TITLEBLOCK FAMILY AND INSERT CAD
TO TRACE OVER.



Date:	07/11/2023
Drawn By:	FS
Reviewed By:	MP
Approved By:	JRC

W&S Project No.: ENG22-1122
W&S File No.: XXX

Drawing Title:

127 S PAMENT RD - 3D VIEWS


Sheet Number:

NOTE: 3D VIEWS ARE PROVIDED FOR REFERENCE ONLY. REFER TO PLANS, ELEVATIONS, SECTIONS, DETAILS AND SCHEDULES FOR BUILDING REQUIREMENTS.


A232

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978.532.1900 800.SAMPSON www.westonandsampson.com PROJECT STATUS Scale: 1/4" = 1'-0"

Key Plan: TO CREATE KEYPLAN, EDIT THE KEYPLAN FAMILY WITHIN THE TITLEBLOCK FAMILY AND INSERT CAD TO TRACE OVER. ROOF EDGE 8' - 0" 07/11/2023 FINISH FLOOR 2' - 1 1/2" GRADE 0' - 0" W&S Project No.: ENG00-00000 Drawing Title: 13 WALSH WAY -BUILDING, WALL AND DETAIL SECTIONS 2 BUILDING SECTION 1/4" = 1'-0" A301 SCALE: 1/8" = 1'-0"

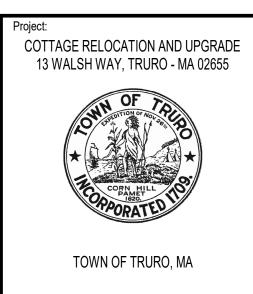

COA:	No.	Date	Description
COA:			

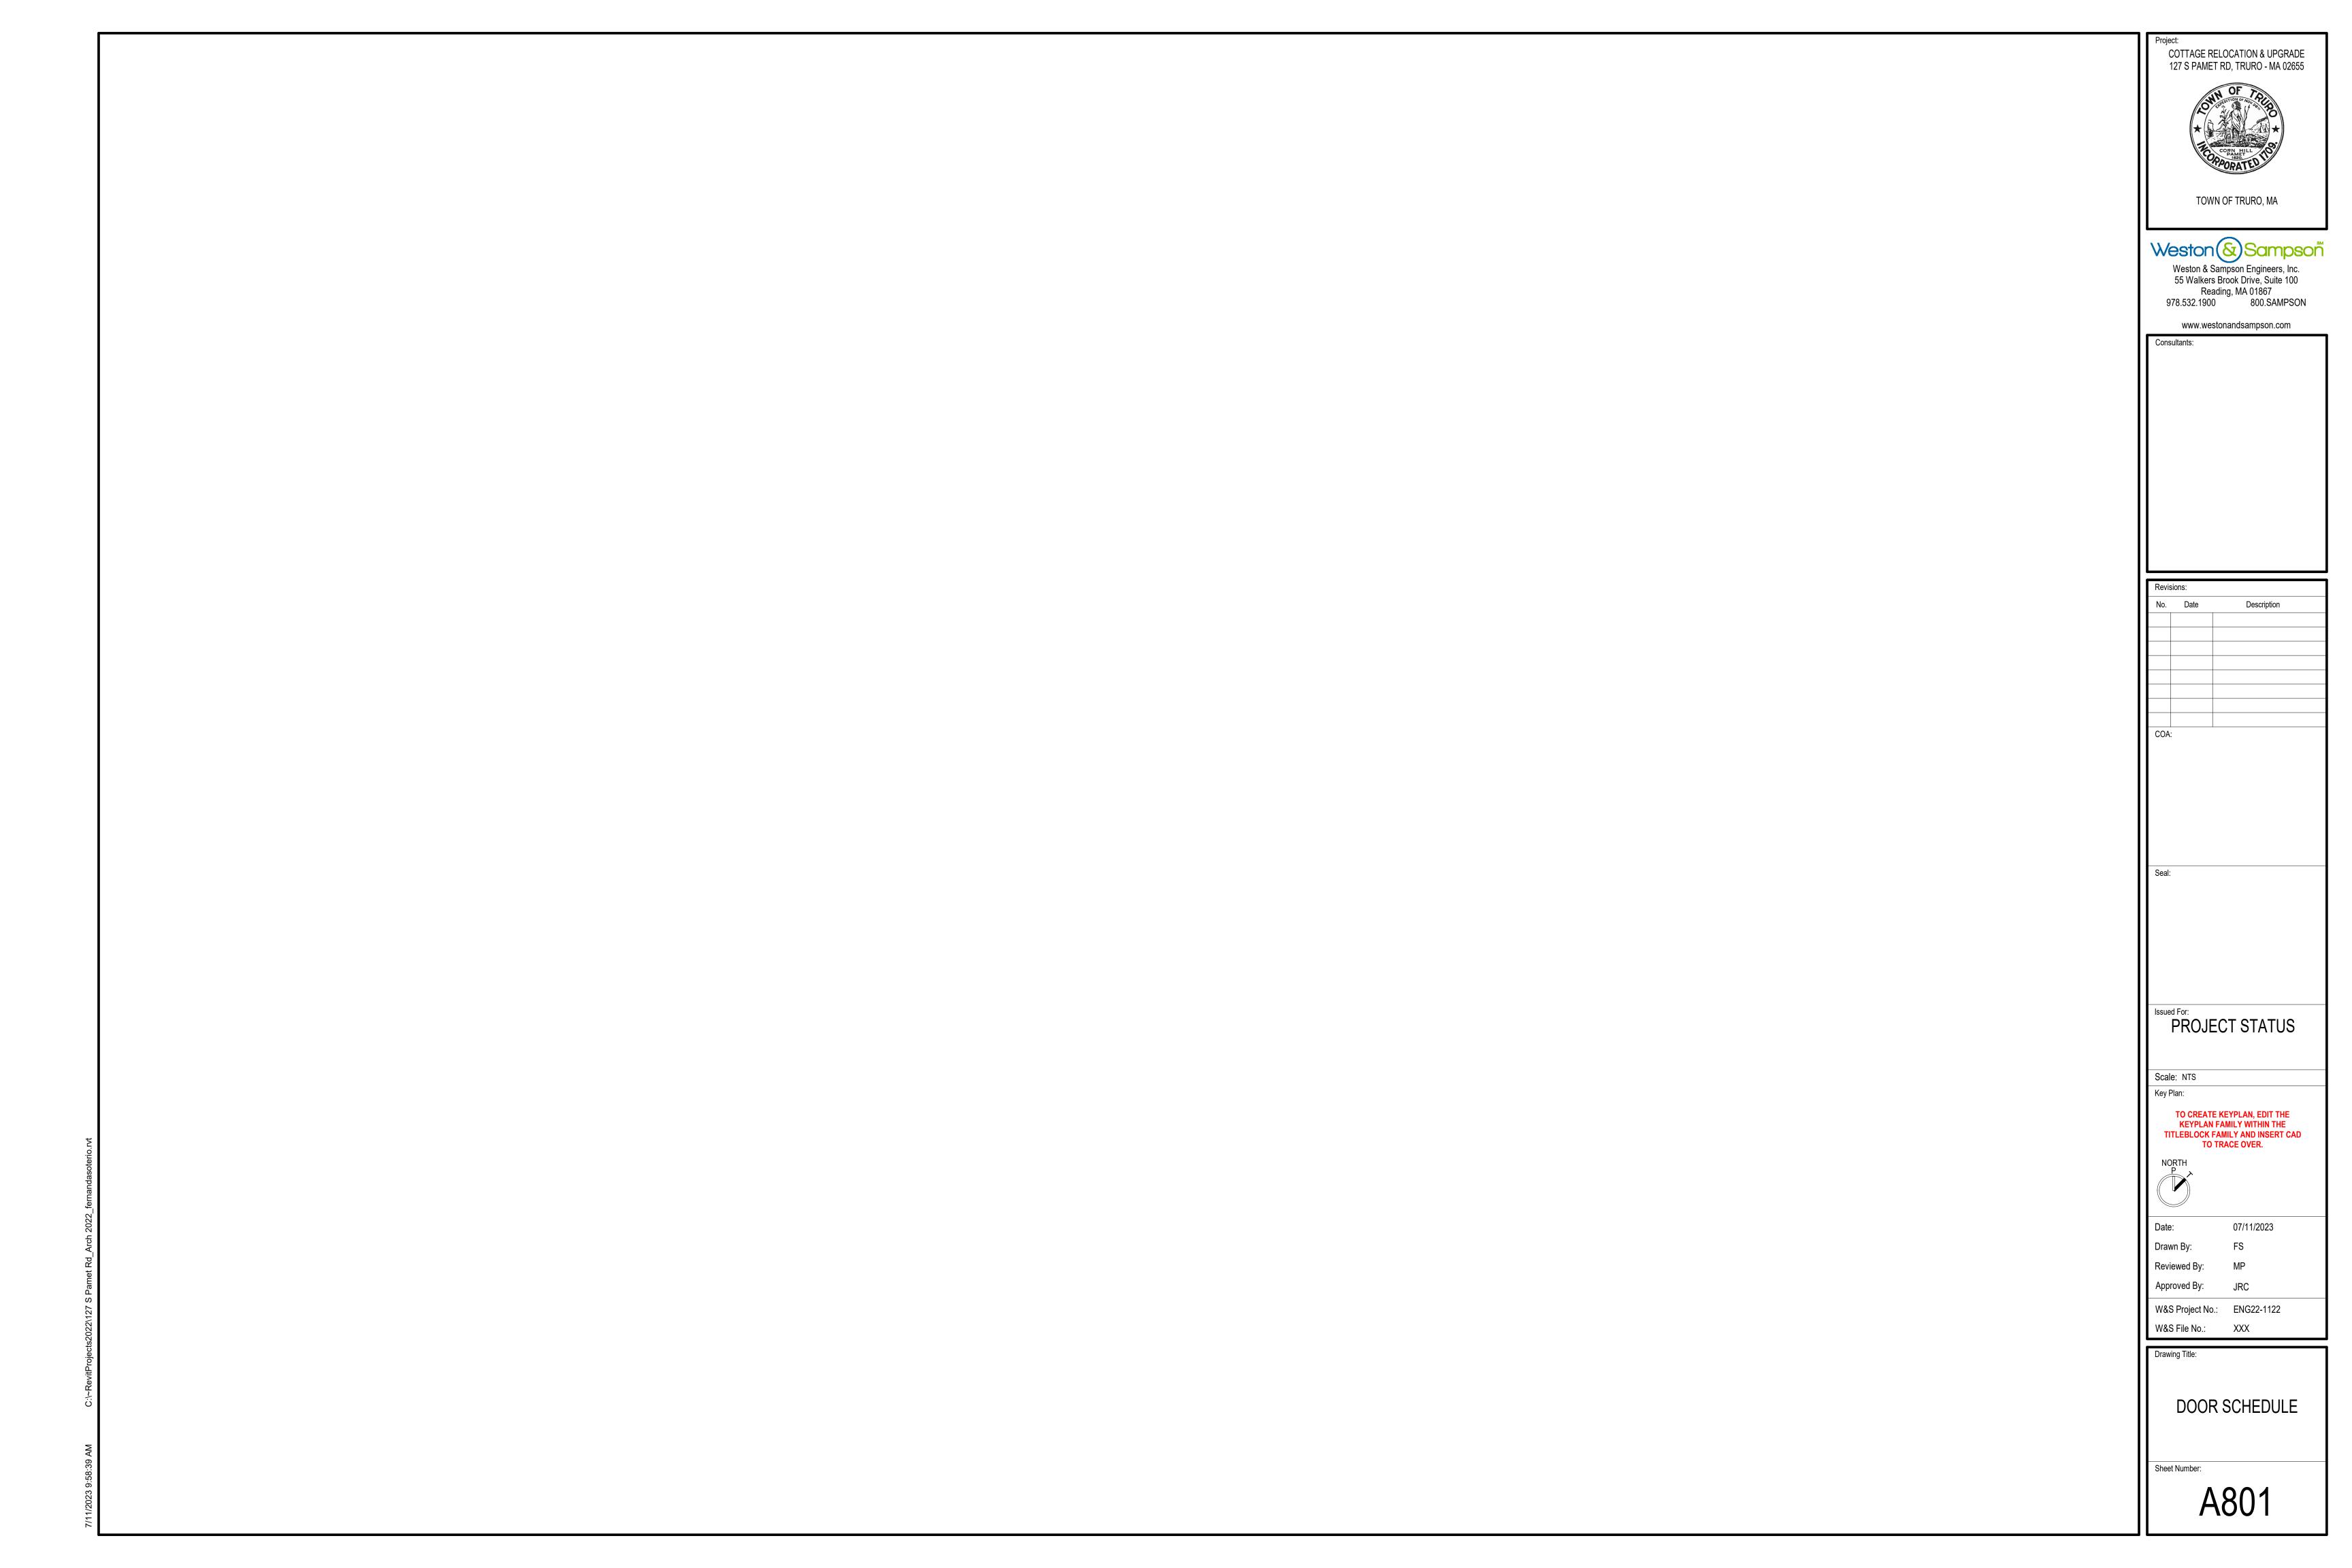

1.0 - GENERAL

- 1.01 THE STRUCTURAL DRAWINGS SHALL BE USED IN CONJUNCTION WITH ALL OTHER CONTRACT DRAWINGS AND SPECIFICATIONS. REFER TO CIVIL, ARCHITECTURAL, MECHANICAL, PLUMBING, AND ELECTRICAL DRAWINGS FOR LOCATION, DIMENSIONS, AND DETAILS OF OPENINGS, SLEEVES, EMBEDMENTS, INSERTS, PADS, CURBS, DEPRESSIONS, ANCHOR BOLTS, AND OTHER PROJECT
- REQUIREMENTS NOT SHOWN ON STRUCTURAL DRAWINGS. 1.02 THE CONTRACTOR IS RESPONSIBLE FOR CHECKING, COORDINATING AND VERIFYING ALL DIMENSIONS IN THE FIELD PRIOR TO COMMENCING WORK. THE CONTRACTOR SHALL IMMEDIATELY REPORT ANY DISCREPANCY TO THE ARCHITECT AND ENGINEER AS A
- 1.03 THE CONTRACTOR IS RESPONSIBLE FOR VERIFYING IN THE FIELD THE EXISTENCE AND LOCATION OF OVERHEAD, BURIED AND/OR EMBEDDED UTILITIES, AND DETERMINING LOCATIONS OF ALL EMBEDDED MECHANICAL, ELECTRICAL AND PLUMBING SYSTEMS AFFECTED BY THE WORK OF THIS CONTRACT.
- 1.04 ALL WORK IS TO CONFORM WITH THE FOLLOWING CODES AND STANDARDS:

REQUEST FOR INFORMATION (RFI) BEFORE PROCEEDING WITH WORK.

- (A) "780 CMR: MASSACHUSETTS AMENDMENTS MASSACHUSETTS STATE BUILDING CODE" 9TH EDITION (MSBC)
- (B) INTERNATIONAL RESIDENTIAL CODE. (IRC 2018) (C) "BUILDING CODE REQUIREMENTS FOR STRUCTURAL CONCRETE" - AMERICAN CONCRETE INSTITUTE (ACI 318)
- (D) "MINIMUM DESIGN LOADS FOR BUILDINGS AND OTHER STRUCTURES" AMERICAN SOCIETY OF CIVIL ENGINEERS, (ASCE 7-10/ASCE 7-16)
- FOR ADDITIONAL CODES AND STANDARDS REFER TO SPECIFICATIONS.
- 1.05 THE CONTRACTOR SHALL NOTIFY THE ARCHITECT AND ENGINEER OF UNFORESEEN CONDITIONS THAT MAY BE UNCOVERED DURING DEMOLITION AND CONSTRUCTION AS A REQUEST FOR INFORMATION (RFI) BEFORE PROCEEDING WITH WORK.
- 1.06 DETAILS AND NOTES SHOWN ON STRUCTURAL DRAWINGS SHALL BE APPLICABLE TO ALL PARTS OF THE STRUCTURAL WORK EXCEPT WHERE SPECIFICALLY REQUIRED OTHERWISE BY CONTRACT DOCUMENTS. CONDITIONS NOT SPECIFICALLY SHOWN SHALL BE SIMILAR TO THOSE SHOWN FOR LIKE CONDITIONS AS DETERMINED BY THE ENGINEER.
- 1.07 THE CONTRACTOR SHALL DESIGN AND PROVIDE ALL REQUIRED SHORING AND TEMPORARY BRACING TO RESIST FORCES ON THE STRUCTURE THROUGHOUT THE CONSTRUCTION PERIOD.

2.0 - FOUNDATIONS

- 2.01 THE CONTRACTOR SHALL DESIGN AND PROVIDE ALL TEMPORARY EARTH SUPPORT, SHORING AND BRACING REQUIRED TO PERFORM THE WORK IN ACCORDANCE WITH OSHA, STATE AND LOCAL REQUIREMENTS.
- 2.02 THE CONTRACTOR SHALL DESIGN AND PROVIDE SHEETING, SHORING, BRACING, AND/OR UNDERPINNING IN ORDER TO PROTECT EXISTING UTILITIES FROM EXCESSIVE MOVEMENTS DURING THE CONSTRUCTION PERIOD, IN ACCORDANCE WITH OSHA, STATE & LOCAL REQUIREMENTS.
- 2.03 THE CONTRACTOR SHALL CARRY OUT CONTINUOUS CONTROL OF SURFACE AND SUBSURFACE WATER. DEWATER ANY AREAS REQUIRING EXCAVATION IN ADVANCE OF PERFORMING EXCAVATION. MAINTAIN GROUNDWATER LEVELS AT LEAST 2 FEET BELOW PLANNED SUBGRADES.
- 2.04 ALL SUBGRADES TO RECEIVE FILL MATERIALS, FOUNDATIONS, SLABS OR OTHER CONSTRUCTION SHALL BE FREE OF RUNNING OR STANDING WATER PRIOR TO PLACEMENT.
- 2.05 FOUNDATIONS SHALL BE INSTALLED IN THE GEOMETRY SHOWN IN THE PLANS, ANY ROCK ENCOUNTERED DURING EXCAVATION SHALL BE REMOVED TO CLEAR THE REQUIRED FOUNDATION GEOMETRY.
- 2.06 SPREAD FOOTING BEARING SURFACES SHALL BE EXCAVATED BY EQUIPMENT WITH A SMOOTH, TOOTHLESS CUTTING EDGE
- 2.07 A MINIMUM 2000 PSF ALLOWABLE BEARING PRESSURE HAS BEEN ASSUMED FOR ALL BUILDING FOUNDATIONS.

3.0 - CAST IN PLACE CONCRETE

- 3.01 CONCRETE WORK SHALL CONFORM TO "BUILDING CODE REQUIREMENTS FOR REINFORCED CONCRETE" (ACI 318) AND "SPECIFICATIONS FOR STRUCTURAL CONCRETE FOR BUILDINGS" (ACI 301).
- 3.02 CONCRETE SHALL BE CONTROLLED CONCRETE, PROPORTIONED, MIXED AND PLACED IN THE PRESENCE OF A REPRESENTATIVE OF AN APPROVED TESTING AGENCY.
- 3.03 UNLESS NOTED OTHERWISE, CONCRETE SHALL BE NORMAL WEIGHT AND HAVE A MINIMUM 28 DAY COMPRESSIVE STRENGTH OF 4000
- 3.04 ALL PERMANENTLY EXPOSED VERTICAL AND HORIZONTAL CONCRETE SURFACES SHALL BE TREATED OR SEALED IN ACCORDANCE
- 3.05 CONCRETE WORK SHALL BE COORDINATED WITH ARCHITECTURAL, MECHANICAL, PLUMBING, AND ELECTRICAL WORK. THE CONTRACTOR SHALL VERIFY INSTALLATION AND LOCATIONS OF ALL EMBEDDED ITEMS INCLUDING BUT NOT LIMITED TO INSERTS, ANCHOR BOLTS, DOWELS, BLOCKOUTS, SLEEVES, EMBEDDED PIPING, AND EMBEDDED CONDUIT PRIOR TO CONCRETE PLACEMENT
- 3.06 CONCRETE EXPOSED TO WEATHER (FREEZE-THAW CONDITIONS) IN THE FINISHED PROJECT SHALL BE AIR ENTRAINED PER SPECIFICATIONS REQUIREMENTS.
- 3.07 A MINIMUM OF 72 HOURS SHALL ELAPSE BETWEEN ADJACENT CONCRETE PLACEMENTS.
- 3.11 PROVIDE A 3/4" CHAMFER ON ALL VERTICAL AND HORIZONTAL CORNERS EXPOSED TO VIEW UNLESS NOTED OTHERWISE.
- 3.12 ALL CONCRETE SHALL BE WATER CURED UNLESS OTHERWISE AUTHORIZED BY THE ENGINEER.
- 3.13 NON-SHRINK, NON-METALLIC, GROUT SHALL HAVE A MINIMUM 28-DAY COMPRESSIVE STRENGTH OF 7,500 PSI (ASTM C942) AND A MINIMUM BOND STRENGTH OF 2,000 PSI AT 28-DAYS (ASTM C882). GROUT MAY BE EXTENDED WITH COARSE AGGREGATE PER THE MANUFACTURER'S RECOMMENDATIONS.

4.0 - DESIGN LOADS:

4.01 GENERAL DESIGN REQUIREMENTS_

	(A) RISK CATEGORY(B) MUNICIPALITY	II (ASCE 7-10, TABLE 1-1) TRURO, MA
4.02	SNOW LOAD	(ASCE 7-10)
	(A) GROUND SNOW LOAD, Pg	25 PSF (780 CMR, TABLE R301.2(4))25 PSF (780 CMR, TABLE R301.2(4))1.0 (ASCE 7-10, TABLE 7-2)1.0 (ASCE 7-10, TABLE 7-4)1.0 (ASCE 7-10, FIGURE 7-2)(MSBC 780 CMR)
4.03	WIND LOADS_	(ASCE 7-10)

(A) BASIC WIND SPEED, V (3-SECOND GUST WIND SPEED)	139 MPH (780 CMR, TABLE R301.2(4
(B) BUILDING ENCLOSURE CLASSIFICATION	ENCLOSED (ASCE 7-10, SEC. 6.2)
(C) WIND EXPOSURE CATEGORY	B (ASCE 7-10, SEC. 6.5.6.3)
(D) DESIGN BUILDING DIMENSIONS	
(E) COMPONENTS AND CLADDING	(ASCE 7-10)
(1) ANALYSIS PROCEDURE	LOW RISE BUILDINGS (ASCE 7-10)
(a) WIND DIRECTIONALITY FACTOR, Kd	0.85 (ASCE 7-10)

1.0 (ASCE 7-10)

_+/-0.18 (ASCE 7-10)


TENSION DEVELOPMENT & SPLICE LENGTHS FOR BARS				
	F'c = 4,000 PSI		F'c = 5,000 PSI	
BAR SIZE	TOP BARS (IN.)	OTHER BARS (IN.)	TOP BARS (IN.)	OTHER BARS (IN.)
#3	24	19	22	17
#4	32	25	29	22
#5	40	31	36	28
#6	48	37	43	33
#7	70	54	63	49
#8	80	62	72	55
#9	91	70	81	63
#10	102	79	91	70
#11	113	87	101	78

MINIMUM SPLICE DEVELOPEMENT LENGTHS

SCALE: 1/2" = 1'-0"


(b) TOPOGRAPHIC FACTOR, Kzt

(c) INTERNAL PRESSURE COEFFICIENT, GCpi_

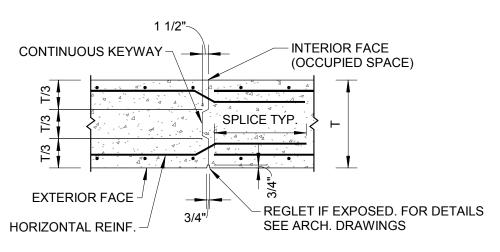


VERTICAL CONSTRUCTION JOINT

SCALE: 1/2" = 1'-0"

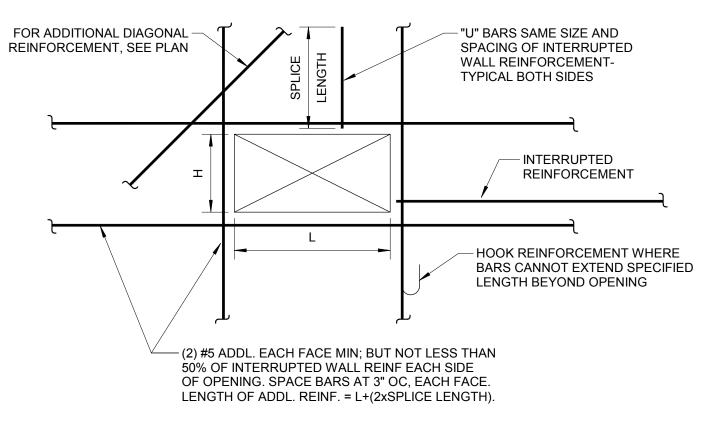

1. WALL OPENINGS SHALL BE COORDINATED AND DETAILED ON THE REINFORCEMENT SHOP DRAWINGS.

REINFORCMENT AT OPENINGS IN REINFORCED CONCRETE WALLS

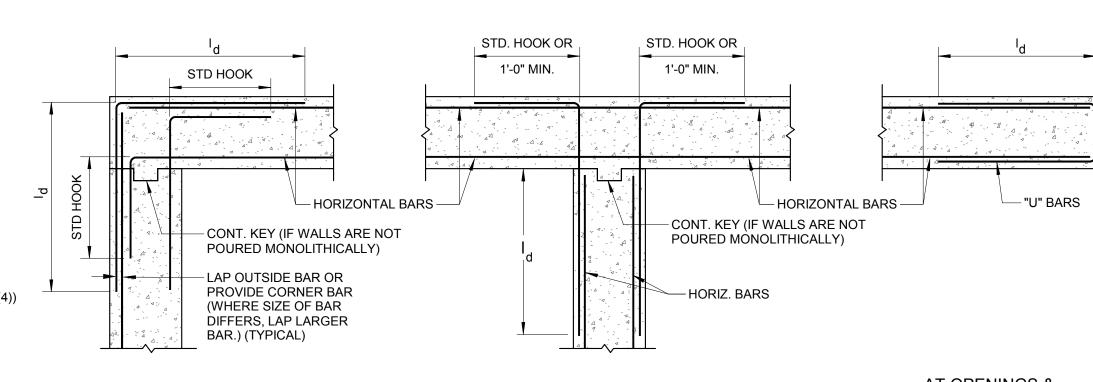


AT CORNERS AT INTERSECTION

AT OPENINGS & <u>DISCONTINUOUS ENDS</u>

1. VERTICAL BARS NOT SHOWN FOR CLARITY. (TYP.) 2. FOR LENGTH OF Id, REFER TO SPLICE AND DEVELOPMENT LENGTH TABLE.

HORIZONTAL WALL REINFORCING PLAN

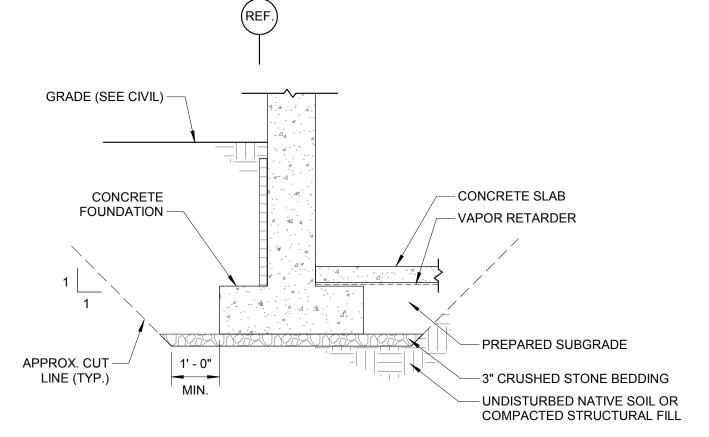

FOUNDATION NOTE(S)

- 1. UNDOCUMENTED FILL AND LOOSE OR DISTURBED SOILS SHALL BE REMOVED FROM ALL FOUNDATION AREAS. THE CONTRACTOR SHALL CONTACT THE ENGINEER PRIOR TO FOUNDATION CONSTRUCTION TO OBSERVE ALL FOUNDATION SUBGRADES. REFER TO EARTHWORK SPECIFICATION FOR LIMITS OF UNSUITABLE SOILS REMOVAL AND BACKFILL REQUIREMENTS
- BELOW FOUNDATIONS AND SLABS. 2. 3-INCHES OF CRUSHED STONES SHALL BE PLACED AND COMPACTED AT THE
- BASE OF FOOTING EXCAVATIONS. 3. THE CONTRACTOR IS RESPONSIBLE FOR SUBGRADE PROTECTION.

SLAB NOTE(S):


- 1. REFER TO EARTHWORK SPECIFICATION FOR PLACEMENT AND COMPACTION REQUIREMENTS. THE CONTRACTOR SHALL CONTACT THE ENGINEER PRIOR TO PLACEMENT TO EVALUATE SUBGRADE CONDITIONS.
- 2. REFER TO EARTHWORK SPECIFICATION FOR LIMITS OF UNSUITABLE SOILS REMOVAL AND BACKFILL REQUIREMENTS BELOW FOUNDATIONS AND SLABS.
- 3. IF UNDERSLAB STONE IS TRAPPING WATER, THE WATER SHALL BE REMOVED PRIOR TO SLAB PLACEMENT.

TYPICAL CUT/FILL DETAIL



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TO TRACE OVER.

Drawn By: Reviewed By: Approved By: W&S Project No.: ENG22-1122

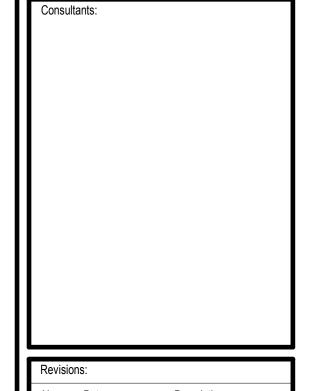W&S File No.:

GENERAL NOTES AND TYPICAL DETAILS

Sheet Number:

NOT FOR CONSTRUCTION

26' - 7" +/-

2. COORDINATE ALL WORK (INCLUDING, BUT NOT LIMITED TO, FLOOR ELEVATIONS, DIMENSIONS, FINISH DETAILS, PENETRATIONS, ETC.) WITH THE ARCHITECTURAL, SITE, EQUIPMENT, PLUMBING, AND MECHANICAL DRAWINGS.

3. [XX'-XX"] INDICATES BOTTOM OF FOOTING ELEVATION. ALL EXTERIOR FOOTINGS SHALL BE LOCATED A MINIMUM OF 4'-0" BELOW FINISHED GRADE. 4. F# - INDICATES NEW CONCRETE SPREAD FOOTING TYPE. SEE FOOTING SCHEDULE ON THIS SHEET FOR DIMENSIONS AND REINFORCING DETAILS.

LO2 INDICATES 8" WIDE X 16" TALL LEAVE OUT AT TOP OF FOUNDATION WALL.
 FOUNDATION WALL LEAVE OUT LOCATIONS SHOWN IN PLAN ARE PRELIMINARY. G.C. TO COORDINATE FINAL SIZE AND POSITION OF ALL LEAVE OUT

9. WALL REINFORCEMENT IS DISCONTINUOUS AT ALL LEAVE OUT LOCATIONS. FILL FOUNDATION WALL LEAVE OUT LOCATIONS WITH NORMAL WEIGHT CONCRETE AFTER EXISTING BUILDING TEMPORARY SUPPORTS HAVE BEEN REMOVED

1. +/- INDICATES EXISTING BUILDING DIMENSION TO BE VERIFIED BY G.C. IN THE FIELD.

5. * INDICATES DIMENSION TO BE COORDINATE BY G.C. WITH BUILDING MOVER 6. LO1 INDICATES 16" WIDE X 24" TALL LEAVE OUT AT TOP OF FOUNDATION WALL

LOCATIONS WITH BUILDING MOVER PRIOR TO CONSTRUCTION

FOUNDATION PLAN

SCALE: 1/4" = 1'-0"

35' - 2" +/-

19' - 7" +/-

8' - 7" +/-

— 10" DIA. CONC.


SONOTUBE PIER

15' - 7" +/-

	FOOTING SCHEDULE				
		DIMENSIONS			
	MARK	WIDTH [FT.]	LENGTH [FT.]	THICKNESS [IN.]	REINFORCEMENT
	F2	2.0	2.0	12	(3) #4 E.W. BOTT. HOOKED

FOOTING NOTE(S):

- 1. SQUARE FOOTING SHALL BE CENTERED BELOW COLUMNS U.N.O. 2. RECTANGULAR FOOTINGS SHALL BE ORIENTED AS SHOWN IN PLAN, U.N.O. 3. WHERE FOOTINGS INTERSECT IN PLAN, FOOTING SHALL BE CAST INTEGRAL
- WITH THE REINFORCING AS SPECIFIED IN THE TABLE ABOVE.

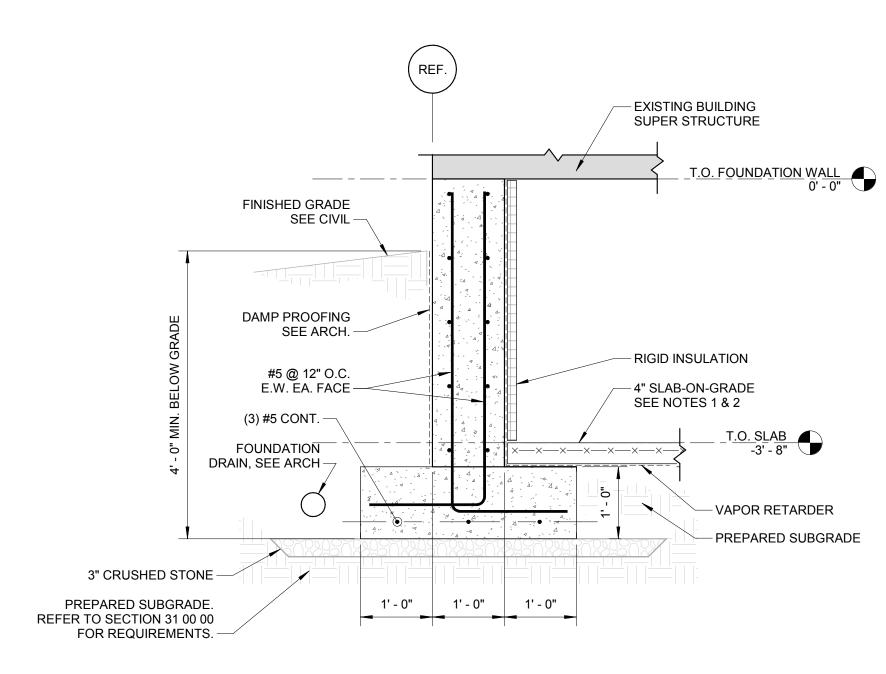

NOTES:
1. REINFORCE SLAB-ON-GRADE WITH 6x6 W1.4xW1.4 WELDED WIRE FABRIC
2. SLOPE SLAB TO FLOOR DRAIN MINIMUM OF 1/8" PER FOOT

2 TYPICAL FOUNDATION SECTION SCALE: 3/4" = 1'-0"



Description

	PROGRESS STATUS		
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	NORTH		
ı	Date:	07/11/23	
ı	Drawn By:	TSM	
ı	Reviewed By: EJP Approved By: NMS W&S Project No.: ENG22-1122 W&S File No.: XXX Drawing Title: 13 WALSH WAY - FOUNDATION PLAN AND TYPICAL SECTIONS		
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Sheet Number:

NOT FOR CONSTRUCTION

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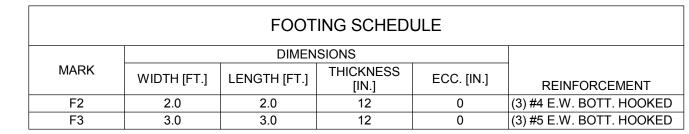
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- 5. * INDICATES DIMENSION TO BE COORDINATE BY G.C. WITH BUILDING MOVER6. LO1 INDICATES 16" WIDE X 24" TALL LEAVE OUT AT TOP OF FOUNDATION WALL
- 7. LO2 INDICATES 16" WIDE X 24" TALL LEAVE OUT AT TOP OF FOUNDATION WALL.
- 8. FOUNDATION WALL LEAVE OUT LOCATIONS SHOWN IN PLAN ARE PRELIMINARY. G.C. TO COORDINATE FINAL SIZE AND POSITION OF ALL LEAVE OUT LOCATIONS WITH BUILDING MOVER PRIOR TO CONSTRUCTION
- 9. WALL REINFORCEMENT IS DISCONTINUOUS AT ALL LEAVE OUT LOCATIONS. FILL FOUNDATION WALL LEAVE OUT LOCATIONS WITH NORMAL WEIGHT CONCRETE AFTER EXISTING BUILDING TEMPORARY SUPPORTS HAVE BEEN REMOVED


1 FOUNDATION PLAN

SCALE: 1/4" = 1'-0"



FOOTING NOTE(S):

- 1. SQUARE FOOTINGS SHALL BE CENTERED BELOW COLUMNS U.N.O.
- RECTANGULAR FOOTINGS SHALL BE ORIENTED AS SHOWN IN PLAN, U.N.O.
 WHERE FOOTING INTERSECT IN PLAN, FOOTING SHALL BE CAST INTEGRAL WITH THE REINFORCING AS SPECIFIED IN THE TABLE ABOVE.

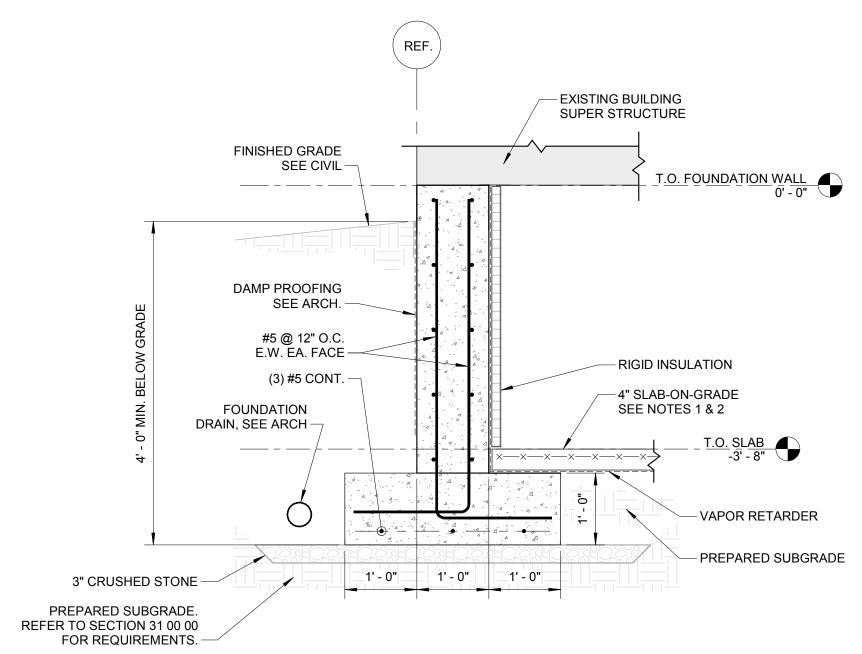

NOTES:

1. REINFORCE SLAB-ON-GRADE WITH 6x6 W1.4xW1.4 WELDED WIRE FABRIC
2. SLOPE SLAB TO FLOOR DRAIN MINIMUM OF 1/8" PER FOOT

2 TYPICAL FOUNDATION SECTION

SCALE: 3/4" = 1'-0"

Project:

PAMET ROAD COTTAGE
25 S HIGHLAND RD, TRURO, MA 02666

TOWN OF TRURO, MA

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Consultatio.

Revisions:

No. Date Description

COA:

ssued For:
PROGRESS STATUS

Scale: As indicated

Key Plan:

TO CREATE KEYPLAN, EDIT THE
KEYPLAN FAMILY WITHIN THE
TITLEBLOCK FAMILY AND INSERT CAD
TO TRACE OVER.

NORTH

Date: 07/11/23

Drawn By: TSM

Reviewed By: EJP

Approved By: NMS

W&S Project No.: ENG22-1122

Drawing Title:

W&S File No.:

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Sheet Number:

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